MSBA ACCELERATED REPAIR PROGRAM WINDOWS, DOORS AND SIDING REPLACEMENT

HALIFAX ELEMENTARY SCHOOL

464 PLYMOUTH ST HALIFAX, MA 02338 MSBA PROJECT # 201601180005

CONSTRUCTION DOCUMENTS DECEMBER 13, 2017

ADDENDUM 1 - 12/21/17
ADDENDUM 2 - 12/26/17
COORDINATION - 1/5/18

ARCHITECT
HABEEB & ASSOCIATES
ARCHITECTS
150 LONGWATER DRIVE
NORWELL, MA 02061
TEL: 781-871-9804 / FAX: 781-871-9805
www.habeebarch.com

OWNER'S PROJECT MANAGER
THE VERTEX COMPANIES, INC.
400 LIBBEY PARKWAY
WEYMOUTH, MA 02189
TEL: 781-952-6000
www.stheran@vertexeng.com

OWNERSHIP AUTHORITY
TOWN OF HALIFAX
499 PLYMOUTH STREET
HALIFAX, MA 02338
TEL: 781-293-6557

DRAWING LIST

GENERAL

A-001 TITLE SHEET

A-002 SITE PLAN

A-003 GENERAL NOTES & LEGEND ARCHITECTURAL DEMOLITION

AD-201 EXTERIOR ELEVATIONS - DEMOLITION

AD-202 EXTERIOR ELEVATIONS - DEMOLITION AD-203 EXTERIOR ELEVATIONS - DEMOLITION

AD-204 EXTERIOR ELEVATIONS - DEMOLITION

AD-501 WINDOW TYPES - DEMOLITION
AD-502 DOOR AND FRAME TYPES - DEMOLITION

AD-511 WINDOW & STOREFRONT DETAILS - DEMOLITION

AD-512 WINDOW & STOREFRONT DETAILS - DEMOLITION

AD-513 WINDOW DETAILS - DEMOLITION AD-521 DOOR DETAILS - DEMOLITION

AD-531 MISC DETAILS - DEMOLITION

AD-531 WISC DETAILS - DEMOLITION

AD-541 WALL DETAILS - DEMOLITION

ARCHITECTURE

A-101 FLOOR PLAN

A-201 EXTERIOR ELEVATIONS
A-202 EXTERIOR ELEVATIONS

A-203 EXTERIOR ELEVATIONS

A-204 EXTERIOR ELEVATIONS
A-210 ENLARGED EXTERIOR ELEVATIONS

A-501 WINDOW TYPES - NEW
A-502 STOREFRONT - DOOR TYPES & DOOR SCHEDULE

A 511 WINDOW & STOREDONT DETAILS

A-511 WINDOW & STOREFRONT DETAILS

A-512 WINDOW & STOREFRONT DETAILS
A-513 WINDOW DETAILS

A-521 DOOR DETAILS
A-531 MISC DETAILS

A-541 WALL DETAILS

A-551 REFLECTED SOFFIT PLAN

LOCUS PLAN (NOT TO SCALE)



ABBEEB&ASSOCIATES



CONSULTANT

RTH ARROW

EY PLAN

SBA ACCELERATED REPAIR PROGRAM
ADOWS, DOORS & SIDING REPLACEMENT

XX ELEMENTARY SCHOOL
PLYMOUTH STREET HALIFAX, MA, 02338

MARK DATE REVISIONS
12/13/17 CONSTRUCTION DOCUMENTS

PROJECT NO: 1614.03


DATE: 12/13/17

SCALE:

DRAWN BY: cjp

CHECKED BY: SB

TITLE SHEET

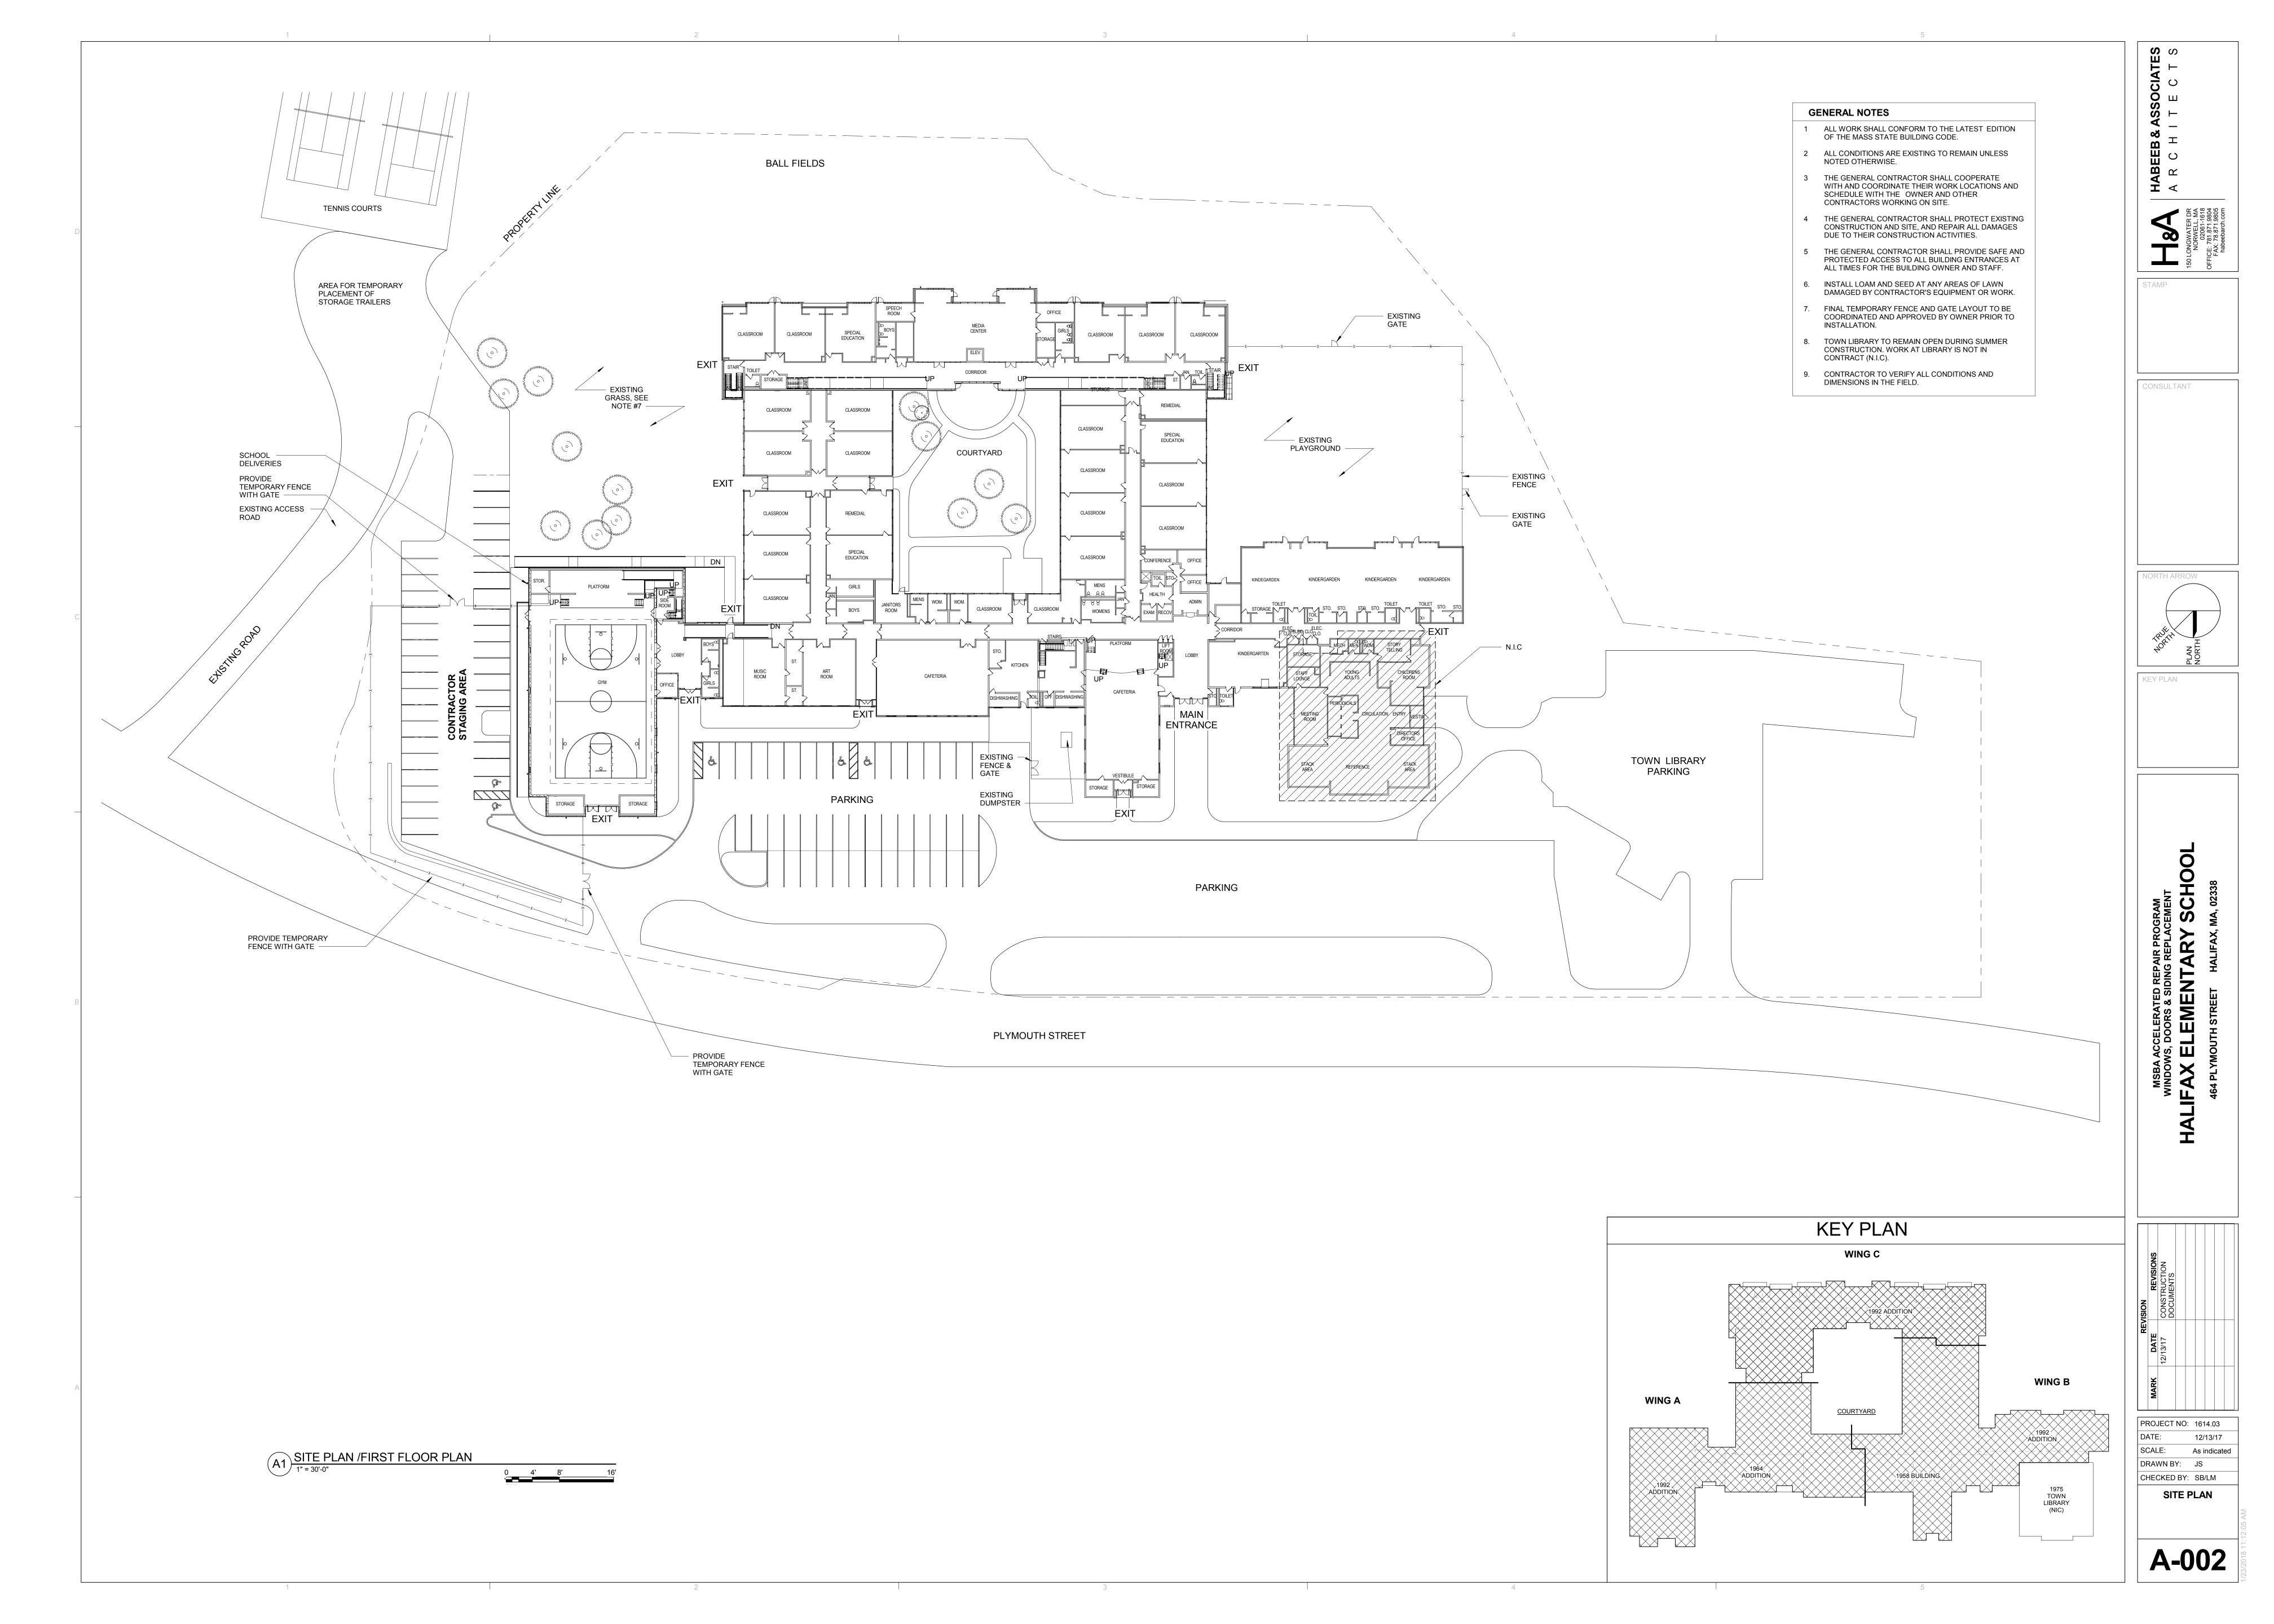

DEMOLITION WORK GENERAL NOTES:

THE FOLLOWING DEMOLITION WORK NOTES ARE TYPICAL TO MULTIPLE CONDITIONS THROUGHOUT THIS PROJECT AND ARE INCLUSIVE OF THE PROJECT SCOPE OF WORK. REFER TO DEMOLITION WINDOW AND DOOR TYPES FOR LOCATIONS OF OTHER SPECIFIC WORK: SEE SPECIFICATION DIVISION 00 FOR EXISTING HAZARDOUS MATERIAL REPORT.

2. SEE SPECIFICATION SECTION 013543 ENVIRONMENTAL PROCEDURES FOR SCOPE OF WORK RELATIVE TO HAZARDOUS MATERIALS, TYPICAL.

3. REMOVE AND PROPERLY DISPOSE OF EXISTING WINDOW & DOOR ASSEMBLIES AT ALL EXTERIOR OPENINGS, INCLUDING: SCREENS, FRAMES, GLAZING, LOUVERS, PANELS, GLAZING COMPOUNDS, FLASHING, BLOCKING, SEALANTS, INSULATION / WOOD PANELING THAT IS ATTACHED TO THE WINDOW ASSEMBLY, TYPICAL (TYP).

4. WHERE REQUIRED, CAREFULLY DETACH CEILING TRACK / SUPPORT FROM WINDOW ASSEMBLY, PROVIDE TEMPORARY SUPPORT AS REQUIRED. PROVIDE NEW SUPPORT FOR CEILING, REPLACE, REPAIR, PAINT CEILING, AND/OR CEILING TILES WITH THE SAME QUALITY AND FINISHES OR EQUAL TO FINISHES IF DAMAGED, TYPICAL.

- REMOVE AND PROTECT EXISTING UNIT VENTILLATOR GRILLES (UVG). RESET AND REINSTALL AS REQUIRED. THE CONTRACTOR SHALL MOVE ALL FURNITURE THAT MAY INTERFERE WITH WORK AN APPROPRIATE DISTANCE AWAY FROM WORK AREA. ALL FURNITURE SHALL BE COVERED AND PROTECTED FROM ANY DAMAGE.
- CONTRACTOR SHALL REPLACE ALL WINDOW STOOLS, APRONS, WOOD TRIM AND CEILINGS DAMAGED DURING DEMOLITION AND CONSTRUCTION. 7. PRIOR TO WINDOW REMOVAL CONTRACTOR SHALL NOTIFY ARCHITECT / OWNER OF ANY DAMAGES THAT MAY AFFECT OR INTERFERE WITH THE WINDOW
- 8. REMOVE ALL EXISTING SHADES AND ROLLERS, INCLUDING CORDS, MOUNTING BRACKETS & ALL FASTENERS, TYPICAL.

REPLACEMENT PROCESS.

9. REMOVE EXISTING WOOD STOP JAMB AND HEAD TRIM AS REQUIRED TO REMOVE ALL CLIP ANCHORS AND FASTENERS, TYPICAL.

10. REMOVE EXISTING EXPOSED OR CONCEALED SEALANTS ON HEADS, JAMBS AND SILLS OF EXISTING WALL CONSTRUCTION AT PERIMETERS OF WINDOW OPENINGS THAT WILL REMAIN EXPOSED AFTER NEW WINDOW SYSTEM PANNING AND TRIM IS INSTALLED OR THAT WHICH INTERFERES WITH WINDOW SYSTEM INSTALLATIONS. SEALANTS SHALL BE REMOVED FLUSH AND SMOOTH TO FACE OF EXISTING WALL CONSTRUCTION SURFACES, TYPICAL.

11. REMOVE EXISTING LOUVER UNITS. WORK TO INCLUDE DISCONNECTION OF INTERIOR SHEET METAL DUCT CONNECTIONS FROM INTERIOR OF LOUVERS, AT UNIT VENTILATORS AND OTHER VENTILATING DUCTWORK OR EQUIPMENT, AND SALVAGE FOR RE-INSTALLATION.

12. COORDINATE DOOR SECURITY ALARM SYSTEM REQUIREMENTS WITH THE OWNER BEFORE DEMOLITION WORK ON DOORS COMMENCES. PROTECT EXISTING ELECTRONIC SECURITY ALARM DOOR CONTACTS AND WIRING ON AND WITHIN EXISTING FRAMES, TYPICAL. REMOVE EXISTING SECURITY ALARM DEVICES AND WIRING LOCATED AT ALL EXTERIOR DOORS, FRAMES & STOREFRONT SYSTEMS. CAREFULLY DISCONNECT WIRING IN CONCEALED LOCATIONS.

13. REMOVE COMPLETE, EXISTING WOOD DOORS, FRAMES AND ALL ATTACHED DOOR OPERATING AND WEATHERSTRIPPING HARDWARE ON DOORS REMOVAL OF EXISTING CLOSERS, CLOSER MOUNTING BRACKETS, DOOR OPERATING HARDWARE AND STRIKES, OFFSET PIVOT OR SURFACE MOUNTED HINGES, FLOOR THRESHOLDS AND FLOOR CLOSER THRESHOLDS AND ALL HARDWARE FASTENERS, TYPICAL.

14. REMOVE EXISTING ELECTRIC STRIKE AND WIRELESS DOOR RELEASE SYSTEM ON DOORS AND FRAMES. REMOVE SYSTEM WIRING SURFACE-MOUNTED ON EXISTING FRAMES. REMOVE AND SALVAGE FOR REINSTALLATION, EXISTING SYSTEM POWER AND TRANSMITTER PANELS FROM FRAMES OR ADJACENT WALLS INCLUDING SURFACE WIRING RACEWAYS ON FRAMES AND CONDUIT ON WALLS. PATCH AND PAINT WALLS AT REMOVED DEVICES AND WIRING, TYPICAL.

15. REMOVE AND SALVAGE FOR REINSTALLATION EXISTING ACOUSTICAL CEILING TILE PANELS AND METAL CEILING GRID SYSTEM TO ALLOW REMOVAL OF EXISTING DOOR FRAME SYSTEMS, TYPICAL.

16. REMOVE COMPLETE, EXISTING RECESSED OFFSET-PIVOT FLOOR CLOSER

OPERATORS AND HOUSINGS CAST INTO EXISTING CONCRETE OR TERRAZZO FLOORING. REMOVE ANCHORS AND FASTENERS, AND RUST AND OIL RESIDUE WITHIN RECESS OF OPENING. REMOVE LOOSE OR BROKEN ADJACENT CONCRETE AND FINISHED FLOORING MATERIALS, TYPICAL.

- 17. REMOVE ALL EXISTING SIDING, TRIM, AND AIR/MOISTURE BARRIER DOWN TO EXISTING SHEATHING UNLESS NOTED OTHERWISE.
- 18. REMOVE EXISTING WINDOW SHADES.

WALL. FILL VOID WITH INSULATION.

19. REMOVE ALL DRY SPRINKLER SYSTEM DRAINS EXPOSED AT THE EXTERIOR

NEW WORK GENERAL NOTES:

THE FOLLOWING NEW WORK NOTES ARE TYPICAL TO MOST CONDITIONS THROUGHOUT THIS PROJECT AND ARE INCLUSIVE OF THE PROJECT SCOPE OF WORK. REFER TO WINDOW AND DOOR TYPES AND DETAILS FOR LOCATIONS OF OTHER SPECIFIC WORK:

1. THE INFORMATION SHOWN ON THE ELEVATIONS WAS COMPILED FROM VARIOUS SOURCES AND MAY NOT REFLECT THE ACTUAL CONDITIONS AT THE TIME OF CONSTRUCTION. THE CONTRACTOR SHALL VERIFY ALL CONDITIONS AND DIMENSIONS IN THE FIELD.

ALL OPENING DIMENSIONS SHOWN ARE PLUS OR MINUS (±) REGARDLESS OF HOW THEY ARE SHOWN OR INDICATED IN DIMENSION LINE AND SHALL BE VERIFIED IN THE FIELD (VIF) PRIOR TO FABRICATION.

3. ANY CONDITION NOT FOUND DETAILED SHALL BE CONSTRUCTED IN A MANNER SIMILAR TO THAT OF THE WINDOW MANUFACTURER'S TYPICAL (TYP) DETAILS. NOTIFY ARCHITECT OF ANY CONDITIONS DISCOVERED WHICH MIGHT REQUIRE AESTHETIC CONSIDERATION OR DETAILING. ARCHITECT SHOULD BE NOTIFIED OF ANY CONDITIONS NOT DETAILED.

4. THE CONTRACTOR SHALL REMOVE AND REPLACE ONLY THE OPENINGS WHICH CAN BE INSTALLED COMPLETE EACH DAY INCLUDING WINDOWS, DOORS, FRAMES, PANNING, SASHES, GLAZING, PANELS, AND SEALANT.

5. REPLACE ALL INTERIOR AND EXTERIOR FINISH MATERIALS EXPOSED TO VIEW WHICH WERE DAMAGED BY WINDOW REPLACEMENT. REPLACEMENT MATERIALS SHALL MATCH EXISTING MATERIALS AND FINISH.

CONTRACTOR SHALL REINSTALL AND RECONNECT ANY SECURITY SENSORS AND SHALL COORDINATE DOOR AND WINDOW REPLACEMENT WITH THE OWNER SO THAT THESE DEVICES CAN BE REINSTALLED ON THE SAME DAY AS REPLACEMENT. REINSTALL EXISTING CONCEALED SECURITY ALARM DEVICES & WIRING FOR ALL NEW DOORS, FRAMES AND STOREFRONT SYSTEMS. CONNECT TO EXISTING SECURITY ALARM SYSTEM. CONFIRM OPERATION OF

7. REPAIR / RESET & FASTEN LOOSE EXISTING BLOCKING, FLASHING AND OTHER ITEMS AT OPENINGS PRIOR TO INSTALLATION OF NEW WINDOW OR DOOR FRAMES.

SECURITY EQUIPMENT AT EACH OPENING AFFECTED.

DOOR. REFER TO SPECIFICATIONS.

8. ALL ELECTRICAL WORK RELATED TO NEW WINDOW, DOOR AND SIDING INSTALLATIONS SHALL BE DONE BY A LICENSED ELECTRICIAN.

9. ALL PLUMBING WORK RELATED TO NEW WINDOW, DOOR AND SIDING INSTALLATIONS SHALL BE DONE BY LICENSED PLUMBER.

10. SECURITY AND/OR INSECT SCREENS TO BE INSTALLED AT ALL OPERABLE WINDOW OPENINGS.

11. SALVAGE ALL EXIT DOOR SIGNS AND REINSTALL IN APPROXIMATELY THE SAME LOCATION AS PREVIOUSLY INSTALLED. SIGNS SHOULD BE ATTACHED TO EITHER A METAL PANEL OR MULLION IN AN APPROPRIATE FASHION.

12. PROVIDE SETS OF NEW INDIVIDUAL 4" W X 8" H ADHESIVE-APPLIED VINYL SIGNAGE WITH 6" H NUMERALS, ONE FOR EACH SIDE OF EVERY EXTERIOR

13. PROVIDE NEW SELF-ADHERING BITUMINOUS MEMBRANE CONTINUOUS STRIP FLASHING FOR ENTIRE PERIMETER OF ALL WINDOW OPENINGS TO COVER ALL NEW OR EXISTING EXPOSED WOOD BLOCKING. LAP ALL FLASHING ONTO ADJACENT EXISTING HEAD, JAMB AND SILL CONSTRUCTION TO WITHIN 1/2" OF OUTERMOST FACE OF ALUMINUM PANNING OR WINDOW FRAMING. FLASHING SHALL BRIDGE ALL GAPS IN BLOCKING AND EXISTING WALL ASSEMBLIES TO PROVIDE A COMPLETE AIR BARRIER ACROSS EXISTING WALL CAVITIES AND BETWEEN THE EXISTING WALL CONSTRUCTION AND THE WINDOW OPENINGS,

14. PAINT UNIT VENTILLATOR GRILLES PRIOR TO REINSTALLATION. REINSTALL EXISTING UNIT VENTILLATOR GRILLE, SET IN BED OF SEALANT. INCLUDE ALL FASTENERS, SHIMS AND SEALANTS. WORK TO INCLUDE RECONNECTION TO EXISTING INTERIOR SHEET METAL DUCTS AT INTERIOR OF LOUVERS WITH NEW SHEET METAL DUCT EXTENSIONS AT UNIT VENTILATORS AND OTHER VENTILATING DUCTWORK OR EQUIPMENT. PAINT EXISTING AND NEW EXPOSED DUCTWORK. INTERIOR WALL FINISHES AT WINDOW OPENINGS AFFECTED BY NEW WORK SHALL BE PATCHED AND PAINTED TO MATCH EXISTING, TYPICAL.

15. PROVIDE NEW BOND BREAKING AND BACKING MATERIALS IN OPEN JOINTS, AND EXTERIOR SEALANT AT PERIMETERS OF ALL NEW WINDOW LIMITS. SEALANTS SHALL BE TOOLED SMOOTH AND FLUSH TO FACE OF PANNING AND CONCAVED ONTO EXISTING WALL CONSTRUCTION SURFACES, TYPICAL.

16. PROVIDE NEW LIGHT-FILTERING FABRIC ROLLER-TYPE WINDOW SHADES INCLUDING MANUAL CLUTCH CHAIN OPERATORS AT ALL WINDOWS SHOWN ON PLANS. PROVIDE ALL MOUNTING BRACKET HARDWARE AND FASTENERS. ROLLER SHADE BRACKETS SHALL BE INSTALLED ON NEW WINDOW FRAMING AT HEIGHT OF EXISTING FINISHED CEILINGS WHERE CEILINGS ABUT WINDOW FRAMING OR INSTALLED ON EXISTING WALL OR CEILING CONSTRUCTION ABOVE WINDOWS AND SHALL EXTEND DOWN TO WINDOW SILL HEIGHTS OR TO TOP OF OTHER RESTRICTIONS, TYPICAL.

17. REINSTALL COMPLETE, REMOVED EXISTING SUSPENDED ACOUSTICAL CEILING SYSTEMS TO MATCH EXISTING, AFTER INSTALLATION OF NEW WINDOW FRAMING SYSTEMS AND TRIM. REPLACE DAMAGED EXISTING ACOUSTICAL CEILING CONSTRUCTION TO MATCH EXISTING.

18. PATCH AND PAINT ALL EXISTING INTERIOR WALLS AND REPAIR EXISTING FINISHED CEILING FINISHES IN ROOMS AND AT WINDOW ALCOVE OPENINGS AFFECTED BY NEW WORK TO MATCH EXISTING, TYPICAL.

19. CLEAN AND PREPARE EXISTING SUB-FLOOR MATERIALS OF RUST AND OIL RESIDUE WITHIN FLOOR OPENINGS AT REMOVED RECESSED FLOOR CLOSER HOUSINGS. PATCH AND FILL SOLID EXISTING FLOOR OPENING RECESSES WITH ACRYLIC-MODIFIED WATER-RESISTANT CEMENT GROUT, FILL EXISTING FLOOR OPENING RECESSES LEVEL AND SMOOTH TO LINES OF EXISTING ADJACENT FLOORING SURFACES. PATCH EXISTING ADJACENT FLOORING DAMAGED BY

REMOVAL WORK TO MATCH EXISTING MATERIALS, TYPICAL.

20. COORDINATE DOOR SECURITY ALARM SYSTEM REQUIREMENTS WITH THE OWNER BEFORE NEW WORK ON FRAMES COMMENCES. REINSTALL EXISTING ELECTRONIC SECURITY ALARM DOOR CONTACTS AND PROVIDE NEW WIRING WITHIN NEW FRAMES, CONNECTING TO EXISTING SECURITY SYSTEM WIRING,

21. PROVIDE NEW WIRING TO NEW CARD READER LOCATIONS SHOWN ON PLAN. RUN WIRING BACK TO EXISTING SECURITY PANEL.

GENERAL NOTES:

1. ALL WORK SHALL BE PERFORMED BY OR UNDER THE SUPERVISION OF THE GENERAL CONTRACTOR AWARDED THE CONTRACT. WORK SHALL INCLUDE BUT NOT BE LIMITED TO ALL RELATED SIDING, PLUMBING, ELECTRICAL AND MECHANICAL SCOPE IN CONJUNCTION WITH THE WINDOW AND DOOR REPLACEMENT PROJECT SCOPE. MINOR PATCHING AND REPAIR OF EXTERIOR AND INTERIOR FINISHES EFFECTED BY THE REMOVAL AND INSTALLATION OF THE WINDOW AND DOOR UNITS IS REQUIRED FOR A FINISHED APPEARANCE THAT MATCHES EXISTING CONDITIONS.

2. PENETRATIONS (ELECTRICAL, FIRE ALARM OR GAS) AT INSULATED PANELS SHALL NOT COMPROMISE ANY WINDOW UNIT.

3. ALL EXTERIOR DOORS ARE ALARMED; CONNECT TO EXISTING SECURITY ALARM SYSTEM. THE CONTRACTOR SHALL TEST ALARM SYSTEM IN-FRONT-OF THE OWNER TO SHOW THAT NEW ALARM DEVICES AND WIRING ARE FUNCTIONING AND CONNECTED TO EXISTING SYSTEM. SYSTEM MUST BE FULLY OPERATIONAL UPON PROJECT CLOSEOUT.

GRADE

4. STORAGE TRAILERS WILL BE ALLOWED ON SITE. OWNER TO APPROVE LOCATION PRIOR TO PLACEMENT

BUILDING ELEVATION LEGEND:


EXISTING WINDOWS OR CURTAINWALL SYSTEMS & TRIM TO BE REMOVED	F=F===================================		<u>DEMOLITION</u>	<u>NEW</u>
NEW FIXED & OPERABLE ALUMINUM WINDOW W/ SECURITY AND/OR INSECT SCREEN; SEE WINDOW TYPES FOR VARIATIONS		DOOR TYPE INDICATOR -SEE EXTERIOR ELEVATIONS AND DOOR TYPES SHEET	(A)	(A)
PROJECTING ALUMINUM WINDOW W/ SECURITY AND/OR INSECT SCREEN; SEE WINDOW TYPES FOR VARIATIONS		WINDOW & STOREFRONT TYPE INDICATOR -SEE EXTERIOR ELEVATIONS AND WINDOW TYPES SHEET	(#)	(#)
EXISTING LOUVER TO REMAIN		WINDOW SHADES WITH LOW POINT OF OPERATING HARDWARE AT 5'-6" A.F.F. MIN. ANY REQUIRED LOOPS OR CHAINS TO BE BREAK-AWAY TYPE.	 Si	Н
ALUMINUM LOUVER IN WINDOW TYPE SASH OR FRAME		EXTERIOR LIGHT FIXTURE	-Ç)- LF
EXISTING DOOR TO BE REMOVED	F = = = = = = = = = = = = = = = = = = =	EXTERIOR WALL SCONCE LIGHT FIXTURE ON PVC PANEL	LF	L
		LOUD SPEAKER	•	LS
		GONG (BELL))
NEW OPERABLE DOOR; SEE ELEVATIONS FOR DOOR TYPES		FIRE ALARM HORN STROBE		FA / HS
		FIRE DEPARTMENT CONNECTION	0	O FDC
		RAIN WATER LEADER	C	RWL
		HOSE BIB		НВ
		JUNCTION BOX (ELECTRICAL)] JB
		DOOR BELL	0	DB
		ELECTRICAL DUPLEX RECEPTACLE		_ EB
		VENT HOOD / DRYER VENT		Z VH


DRY SPRINKLER SYSTEM DRAIN


ABREVIATION LIST:

ACOUST.	ACOUSTICAL	DN.	DOWN	G.S.U.	GLAZED STRUCTURAL UNIT	M.T.	METAL THRESHOLD	SH.	SHELVES	W.P.	WATERPROOFING
A.D.	AREA DRAIN	DO.	DITTO (REPEAT)	GYP.	GYPSUM	MTD.	MOUNTED	SHT.	SHEET	WT.	WEIGHT
ADJ.	ADJUSTABLE	D.O.	DOOR OPENING	G.W.B.	GYPSUM WALLBOARD	MTL.	METAL	S.I.G.S.	SILICON IMPREGNATED	W.W.M.	WELDED WIRE MESH
AFF	ABOVE FINISHED FLOOR	DSP.	DISPENSER	НВ	HOSE BIBB	M.M.C.	MISC. METAL CONTRACTOR		GYPSUM SHEATHING	Χ	INDICATES TIMES OR BY
ALU.	ALUMINUM	D.W.	DRY WALL	H.C.	HANDICAP			SIM.	SIMILAR	YD.	YARD
ALUM.	ALUMINUM	DWG.	DRAWING	H.C.P.	HANDICAP	NAT.	NATURAL	SLID.	SLIDING	Z	ZEE (STRUCTURAL SHAPE)
ANCH.	ANCHOR			H.C.P.	HANDICAP	N.C.	NONCORROSIVE	SPEC.	SPECIFICATIONS		
APPROX.	APPROXIMATELY	EA.	EACH	HD	HIGH DENSITY	N.I.C.	NOT IN CONTRACT	SQ.	SQUARE	СВ	CORNER BOARD
		ED.	EDUCATION	HDWR.	HARDWARE	NO./#	NUMBER	STOR.	STORAGE	OB	CONTRACTOR
@	AT	EDSP.	ENDSPLASH	H.M.	HOLLOW METAL	NOM.	NOMINAL	STOR.	STORAGE	UVG	UNIT VENTILATOR GRILL
DD	DOADD	E.J.	EXPANSION JOINT	HORIZ.	HORIZONTAL	110111.		СТ	CTDLICTLIDAL TUDE		
BD.	BOARD	EL.	ELEVATION (GRADE)	HR.	HOUR	O.A.	OVERALL	S.T.	STRUCTURAL TUBE		
BKSP.	BACKSPALSH	ELEC.	ELECTRICAL	HT.	HEIGHT	O.C.	ON CENTER	S.S.	STAINLESS STEEL		
BKT.	BRACKET	ELEV.	ELEVATION (FACADE)	HVAC	HEATING, VENTILATING	0.D.	OUTSIDE DIAMETER	STD.	STANDARD		
BLDG.	BUILDING		ELEVATION (FACADE)	TIVAC	& AIR CONDITIONING		OPPOSITE HAND	STL.	STEEL		
BLK.	BLOCK	ELEV.			& AIR CONDITIONING	O.H.		STRUCT.	STRUCTURAL		
BLKG.	BLOCKING	EQ.	EQUAL	I.D.	INSIDE DIAMETER	OPER.	OPERATE	SUSP.	SUSPENDED		
BM.	BEAM	E.S.	EACH SIDE	IN.	INCH, INCHES	OPNG.	OPENING	T.	TREADS		
BOT.	BOTTOM	E.T.R.	EXISTING TO REMAIN	IN.2	SQUARE INCHES	OVHD.	OVERHEAD	TBLE.	TABLE		
BSMT.	BASEMENT	EXH.	EXHAUST	IN.3	CUBIC INCHES	OZ.	OUNCE(S)	T.B.		SPLAY BOARD)	
		EXIST.	EXITING		INCANDESCENT	PARTN.	PARTITION	T.C.	TERRA COTTA	or Extr Bortite)	
CG	CORNER GUARD	EXP. JT.	EXPANSION JOINT	INCAN.	INFILTRATION	PERIM.	PERIMETER	TEL.	TELEPHONE		
CAB.	CABINET	EXP.	EXPOSED	INFIL. INSUL.	INSULATION	PERP.	PERPENDICULAR (TO)	TERR.	TERRAZZO		
C.B.	CORNER BOARD	EXT.	EXTERIOR			P.L.	PLASTIC LAMINATE	T&G	TONGUE & GROOVE		
CEM.	CEMENT	EXTIN.	EXTINGUISHER	INT.	INTERIOR		PLATE				
CER./C.T.	CERAMIC TILE	F.C.P.	FIBER CEMENT PANEL	INV.	INVERT	PL.		THK.	THICKNESS		
C.G.	CORNER GUARD	F.D.C.	FIRE DEPT. CONNECTION			PLAS.	PLASTER	THRESH.	THRESHOLD		
C.I.	CAST IRON	F.D.V.	FIRE DEPT. VALVE	JST.	JOIST	PLUMB.	PLUMBING	TLT.	TOILET		
C.I.P.	CAST IN PLACE	F.D.V.C.	FIRE DEPT. VALVE CABINET	JT.	JOINT	PLYWD.	PLYWOOD	T.O.B.	TOP OF BLOCKING		
C.J.	CONTROL JOINT	FB.	FLAT BAR			PNL.	PANEL	T.O.C.	TOP OF CONCRETE		
CLG.	CEILING	F.C.	FIBER CEMENT			POL.	POLISHED	T.O.S.	TOP OF STEEL		
CLKG.	CHALKING	F.D.	FLOOR DRAIN	LAM.	LAMINATED	PR.	PAIR	T.W.	TOP OF WALL		
CLRG.	CLEAR	F.E.	FIRE EXTINGUISHER	LB./#	POUND	PTD.	PAINTED	TYP.	TYPICAL		
CLOS.	CLOSET	F.E.C.	FIRE EXTINGUISHER	L.C.	LEAD COATED	P.T.	PRESSURE TREATED	TWR.	TOWER		
C.M.U.		r.E.U.		L.D.P.	LAMINATED DRYWALL PART.	PVC	POLYVINYL CHLORIDE	шс	LINDEDOLIT		
	CONC. MASONRY UNIT		CABINET	LGTH.	LENGTH			U.C.	UNDERCUT		
C.O.	CLEAR OPENING	F.F.	FACTORY FINISH	L.G.M.F.	LIGHT GAGE METAL FRAMING	Q.T.	QUARRY TILE	U.L.	UNDERWRITERS LABORATORY		
COL.	COLUMN	F.H.	FLAT HEAD	L.O.W.	LIMIT OF WORK	QTY.	QUANTITY	U.O.N.	UNLESS OTHERWISE NOTED		
CONC.	CONCRETE	F.H.C.	FIRE HOSE CABINET	L.P.	LOW POINT	QTT.	Q0/111111	U.P.R.	UPPER		
C.H.P.	CONC. HOUSEKEEPING PAD	FIN.	FINISH	LI.WT.	LIGHT WEIGHT		RADIUS	U.V.	UNIT VENTILATOR		
COND.	CONDITION	FL.	FLOOR	LVR.	LOUVER	r. R.	RISER	UVG	UNIT VENTILATOR GRILLE		
CONST.	CONSTRUCTION	FLASH.	FLASHING					V.C.	VINYL CLAD		
CONT.	CONTINUOUS	FLUOR.	FLUORESCENT	MACH.	MACHINE	RAD. ENCL.	RADIATOR ENCLOSURE	VENT.	VENTILATOR		
CONTR.	CONTRACTOR	F.O.	FRAMED OPENING	MAS.	MASONRY	R.D.	ROOF DRAIN	VERT.	VERTICAL		
CORR.	CORRIDOR	F.P.	FIRE PROOFING	MAT.	MATERIAL	REINF.	REINFORCING	VEST.	VESTIBULE		
C.R.	COLD ROLLED	F.S.	FIRE SHIELD	MAX.	MAXIMUM	REFIG.	REFRIGERATOR	V.W.C.	VINYL WALL COVERING		
CRS.	COURSES	F.SZ.	FULL SIZE	MECH.	MECHANICAL	REQD.	REQUIRED				
CSK.	COUNTERSINK	FT.	FEET/FOOT	MEMBR.	MEMBRANE	RESIL.	RESILIENT	W.	WIDE, WIDE FLANGE		
CTOP	COUNTERTOP	FT.2	SQUARE FEET			RET.	RETAINING	W/	WITH		
CU.	CUBIC	FT.3	CUBIC FEET	M.D.	METAL DOOR	RM.	ROOM	W.C.	WATER CLOSET		
C.U.H.	CABINET UNIT HEATER	FTR	FIN-TUBED RADIATOR	MFGR.	MANUFACTURER	R.O.	ROUGH OPENING	WD.	WOOD		
			FURRING	MIN.	MINIMUM	R.W.L.	RAIN WATER LEADER	W.D.	WINDOW DIMENSION		
D.A.	DOUBLE ACTING	FUR.		MISC.	MISCELLANEOUS	RB.	RESILIENT BASE	W.I.	WROUGHT IRON		
D.A.F.S.	DIRECT APPLIED FINISH	GA.	GAUGE	MLDG.	MOLDING	SC.	SCUPPER	WIND.	WINDOW		
	SYSTEM	GALV.	GALVANIZED	M.O.	MASONRY OPENING	SAM	SELF ADHERED MEMBRANE	W.B.	WHITE BOARD (MAKER BOARD)		
DET.	DETAIL	G.C.	GENERAL CONTRACTOR			SCHED.	SCHEDULE	W.O.	WINDOW OPENING		
D.F.	DRINKING FOUNTAIN	GL.	GLASS			SECT.	SECTION	11.0.	WINDOW OF EMINO		
		CP	CPADE			··					



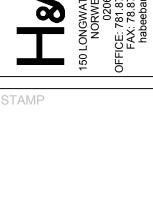


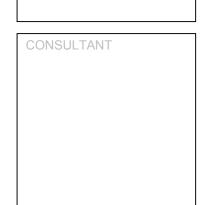

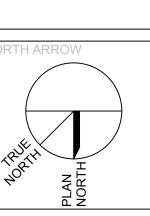






O FP DR

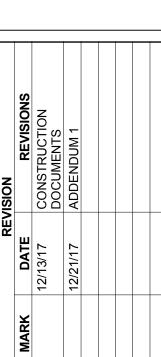



PROJECT NO: 1614.03 12/13/17 1/4" = 1'-0" DRAWN BY: Author CHECKED BY: Checker **GENERAL NOTES & LEGEND**

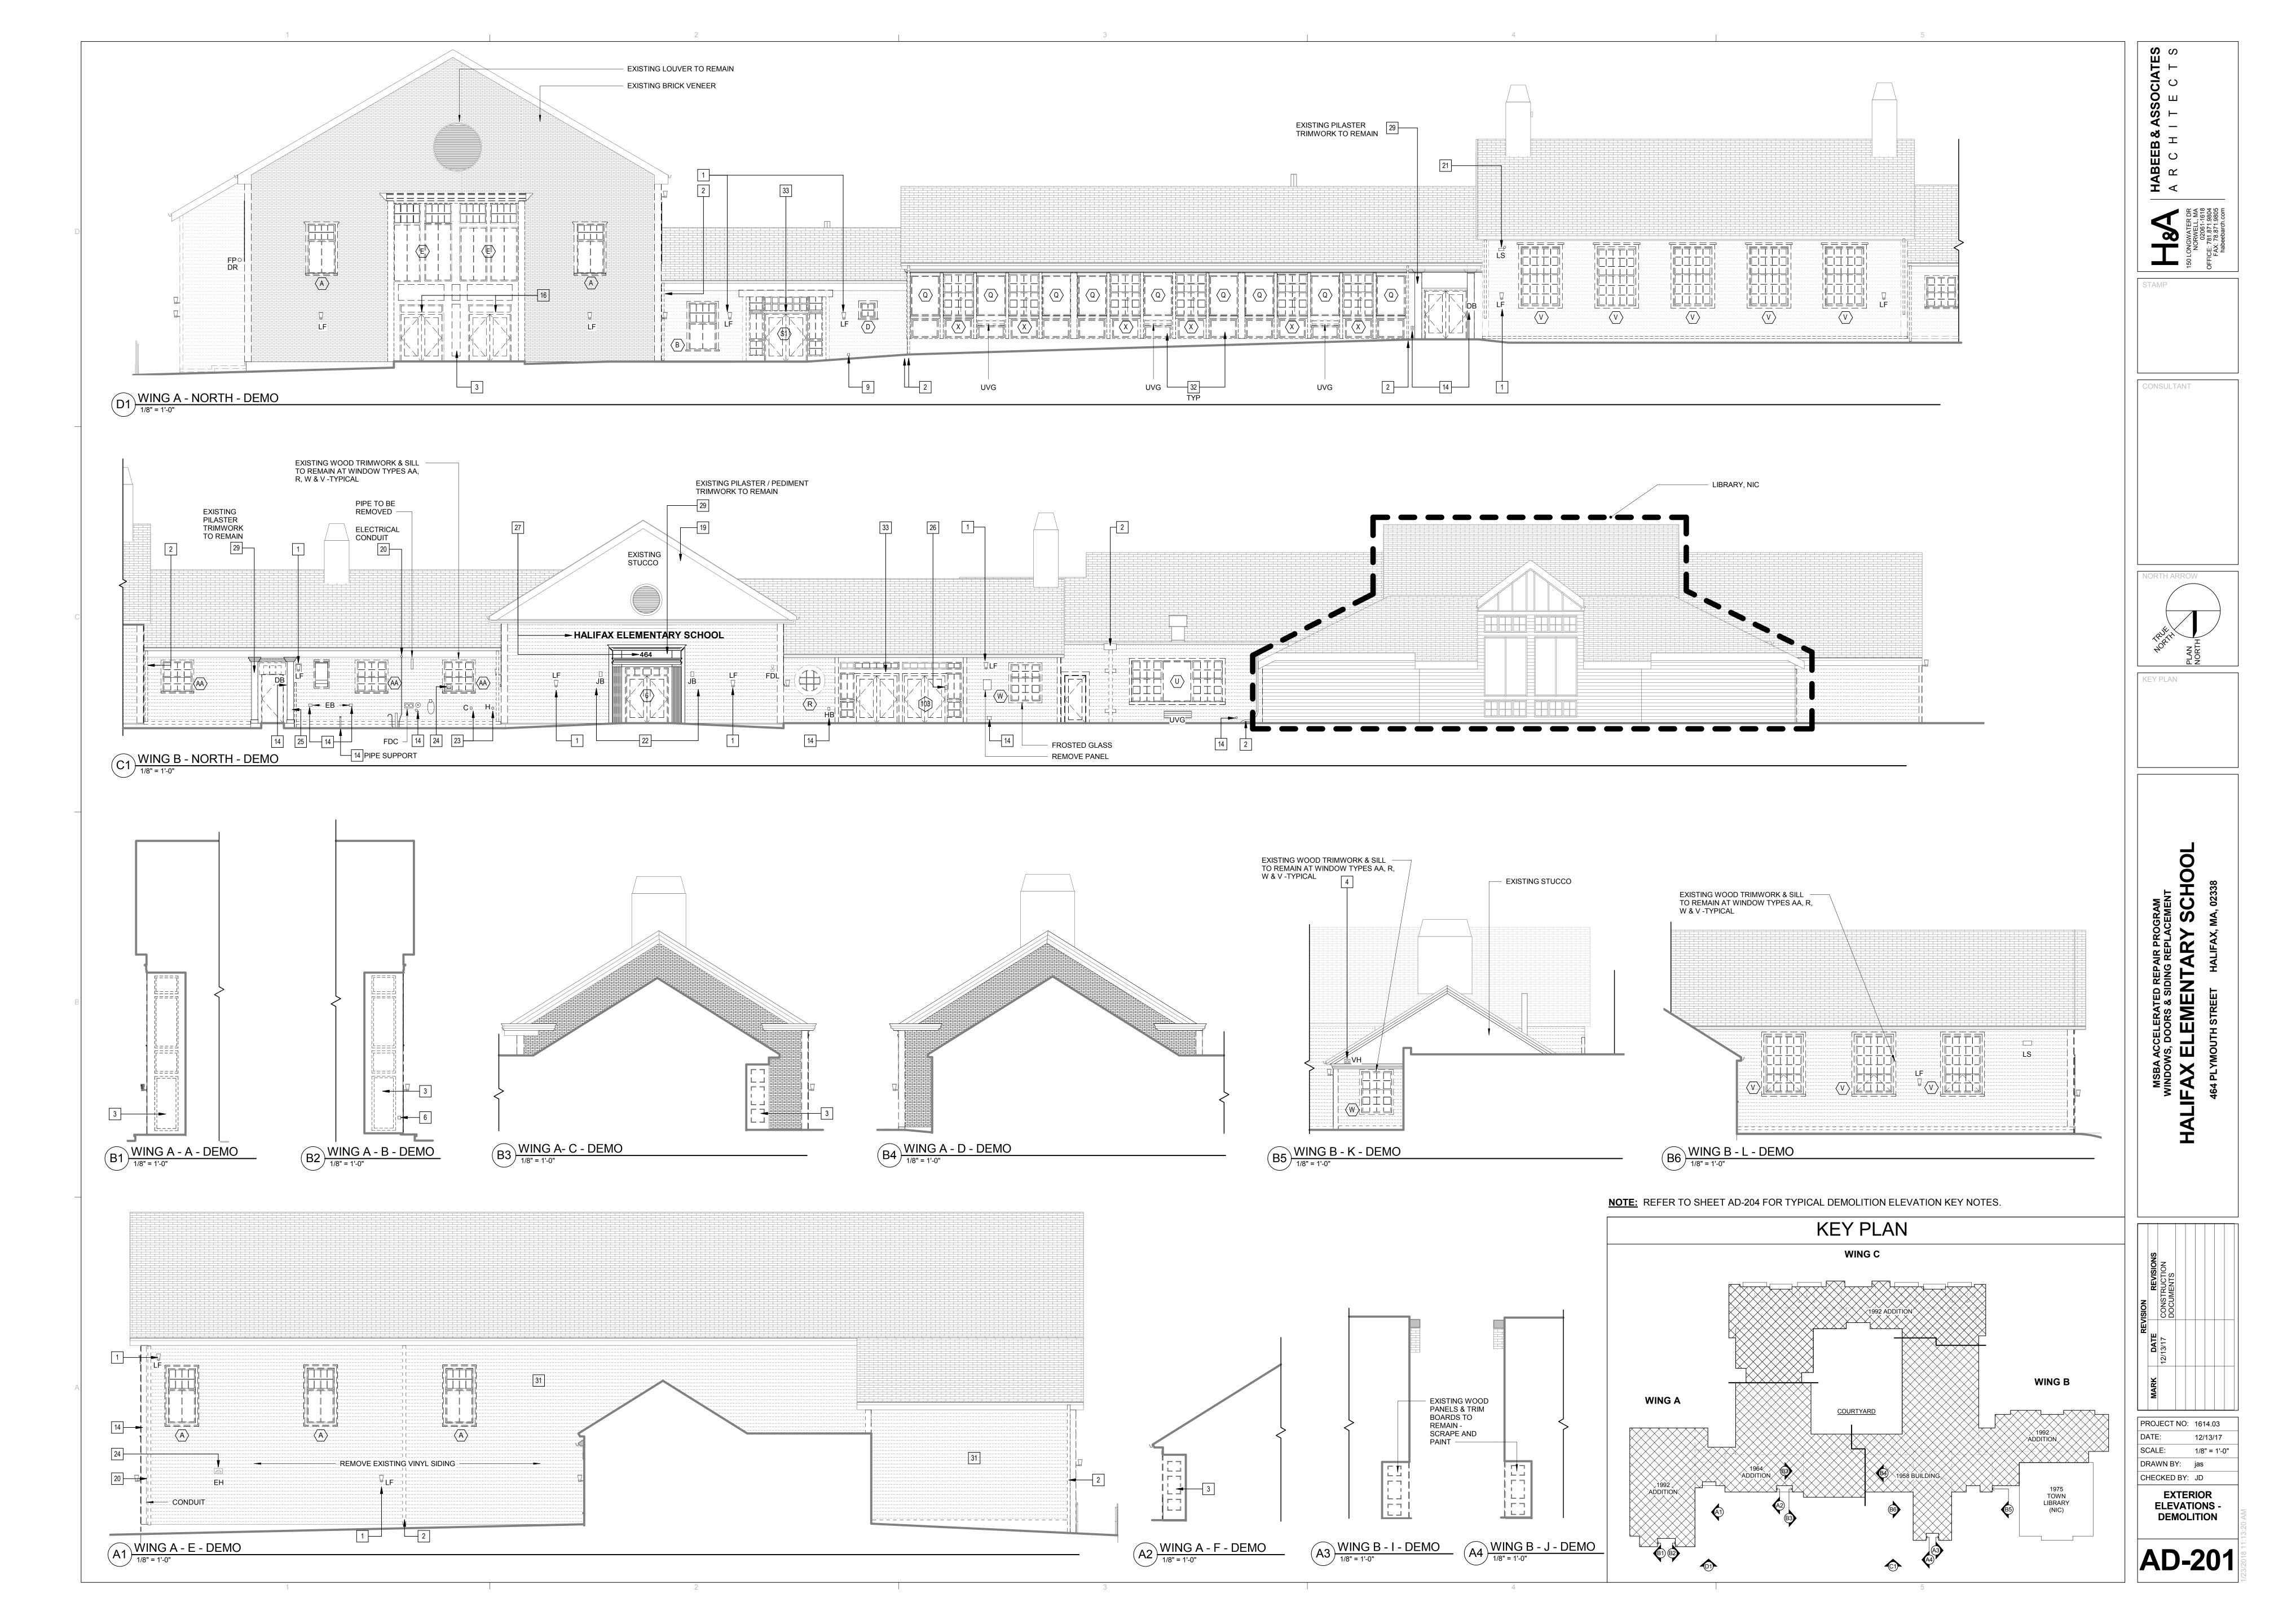


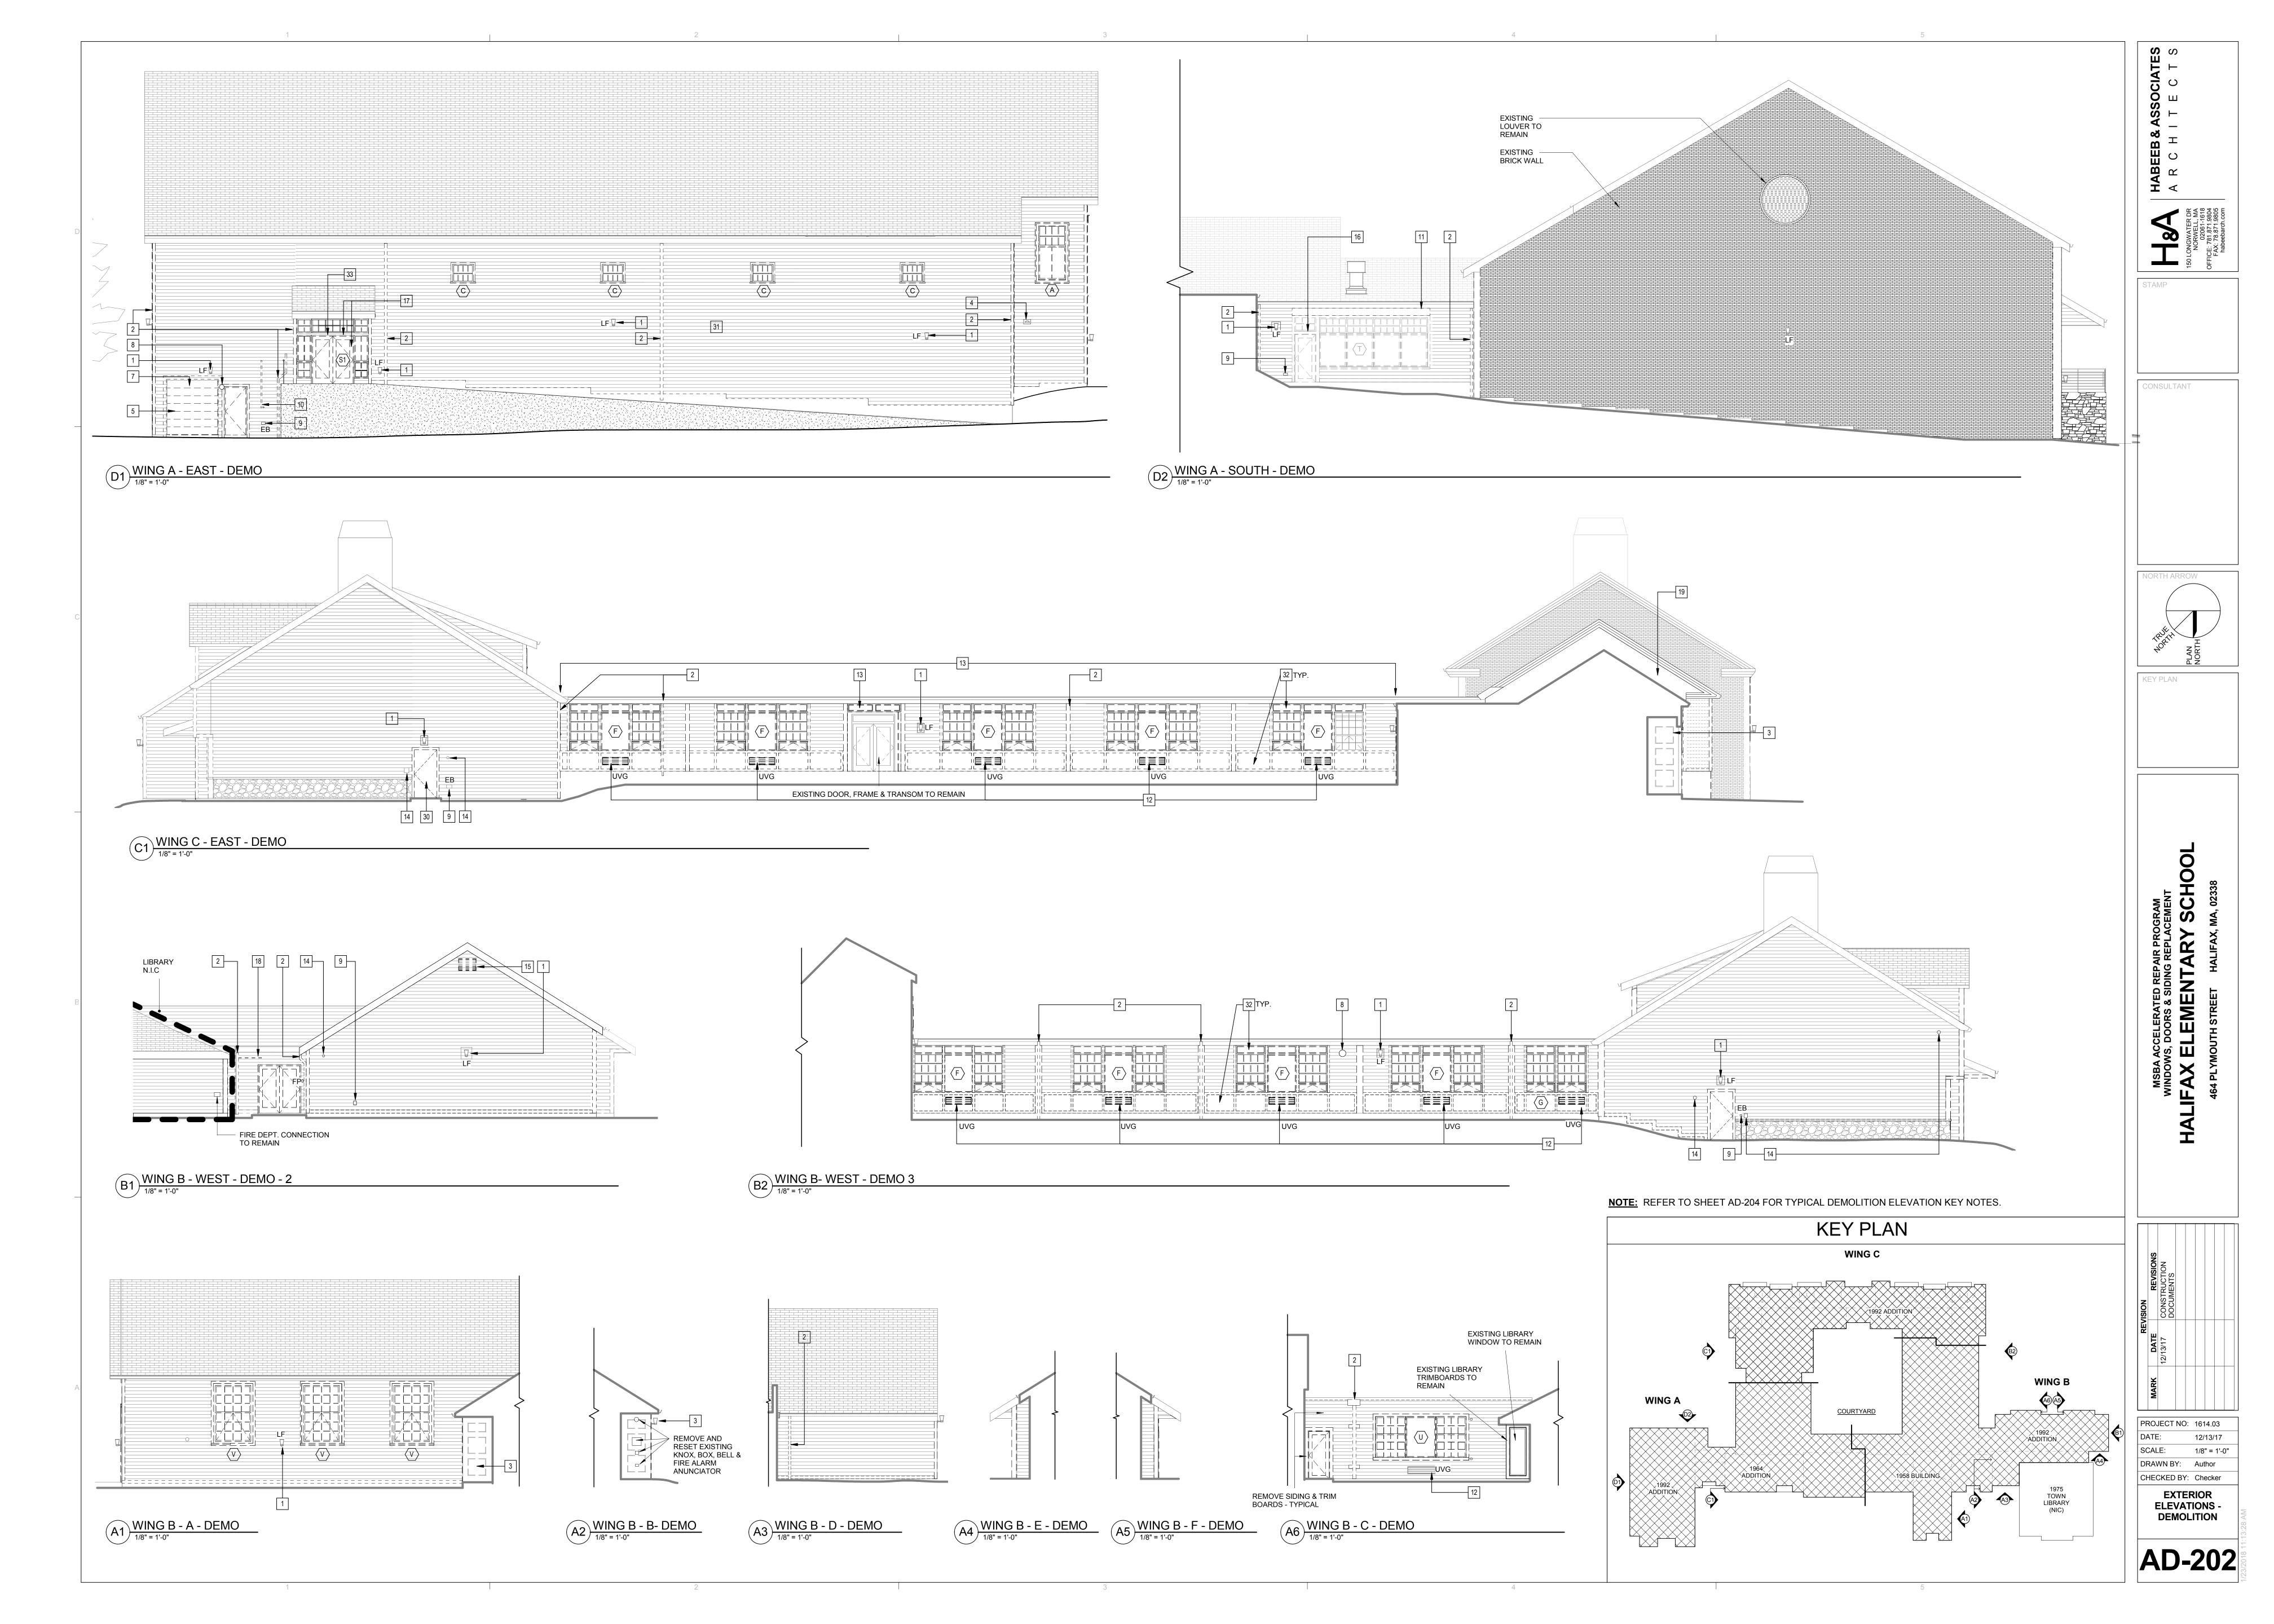


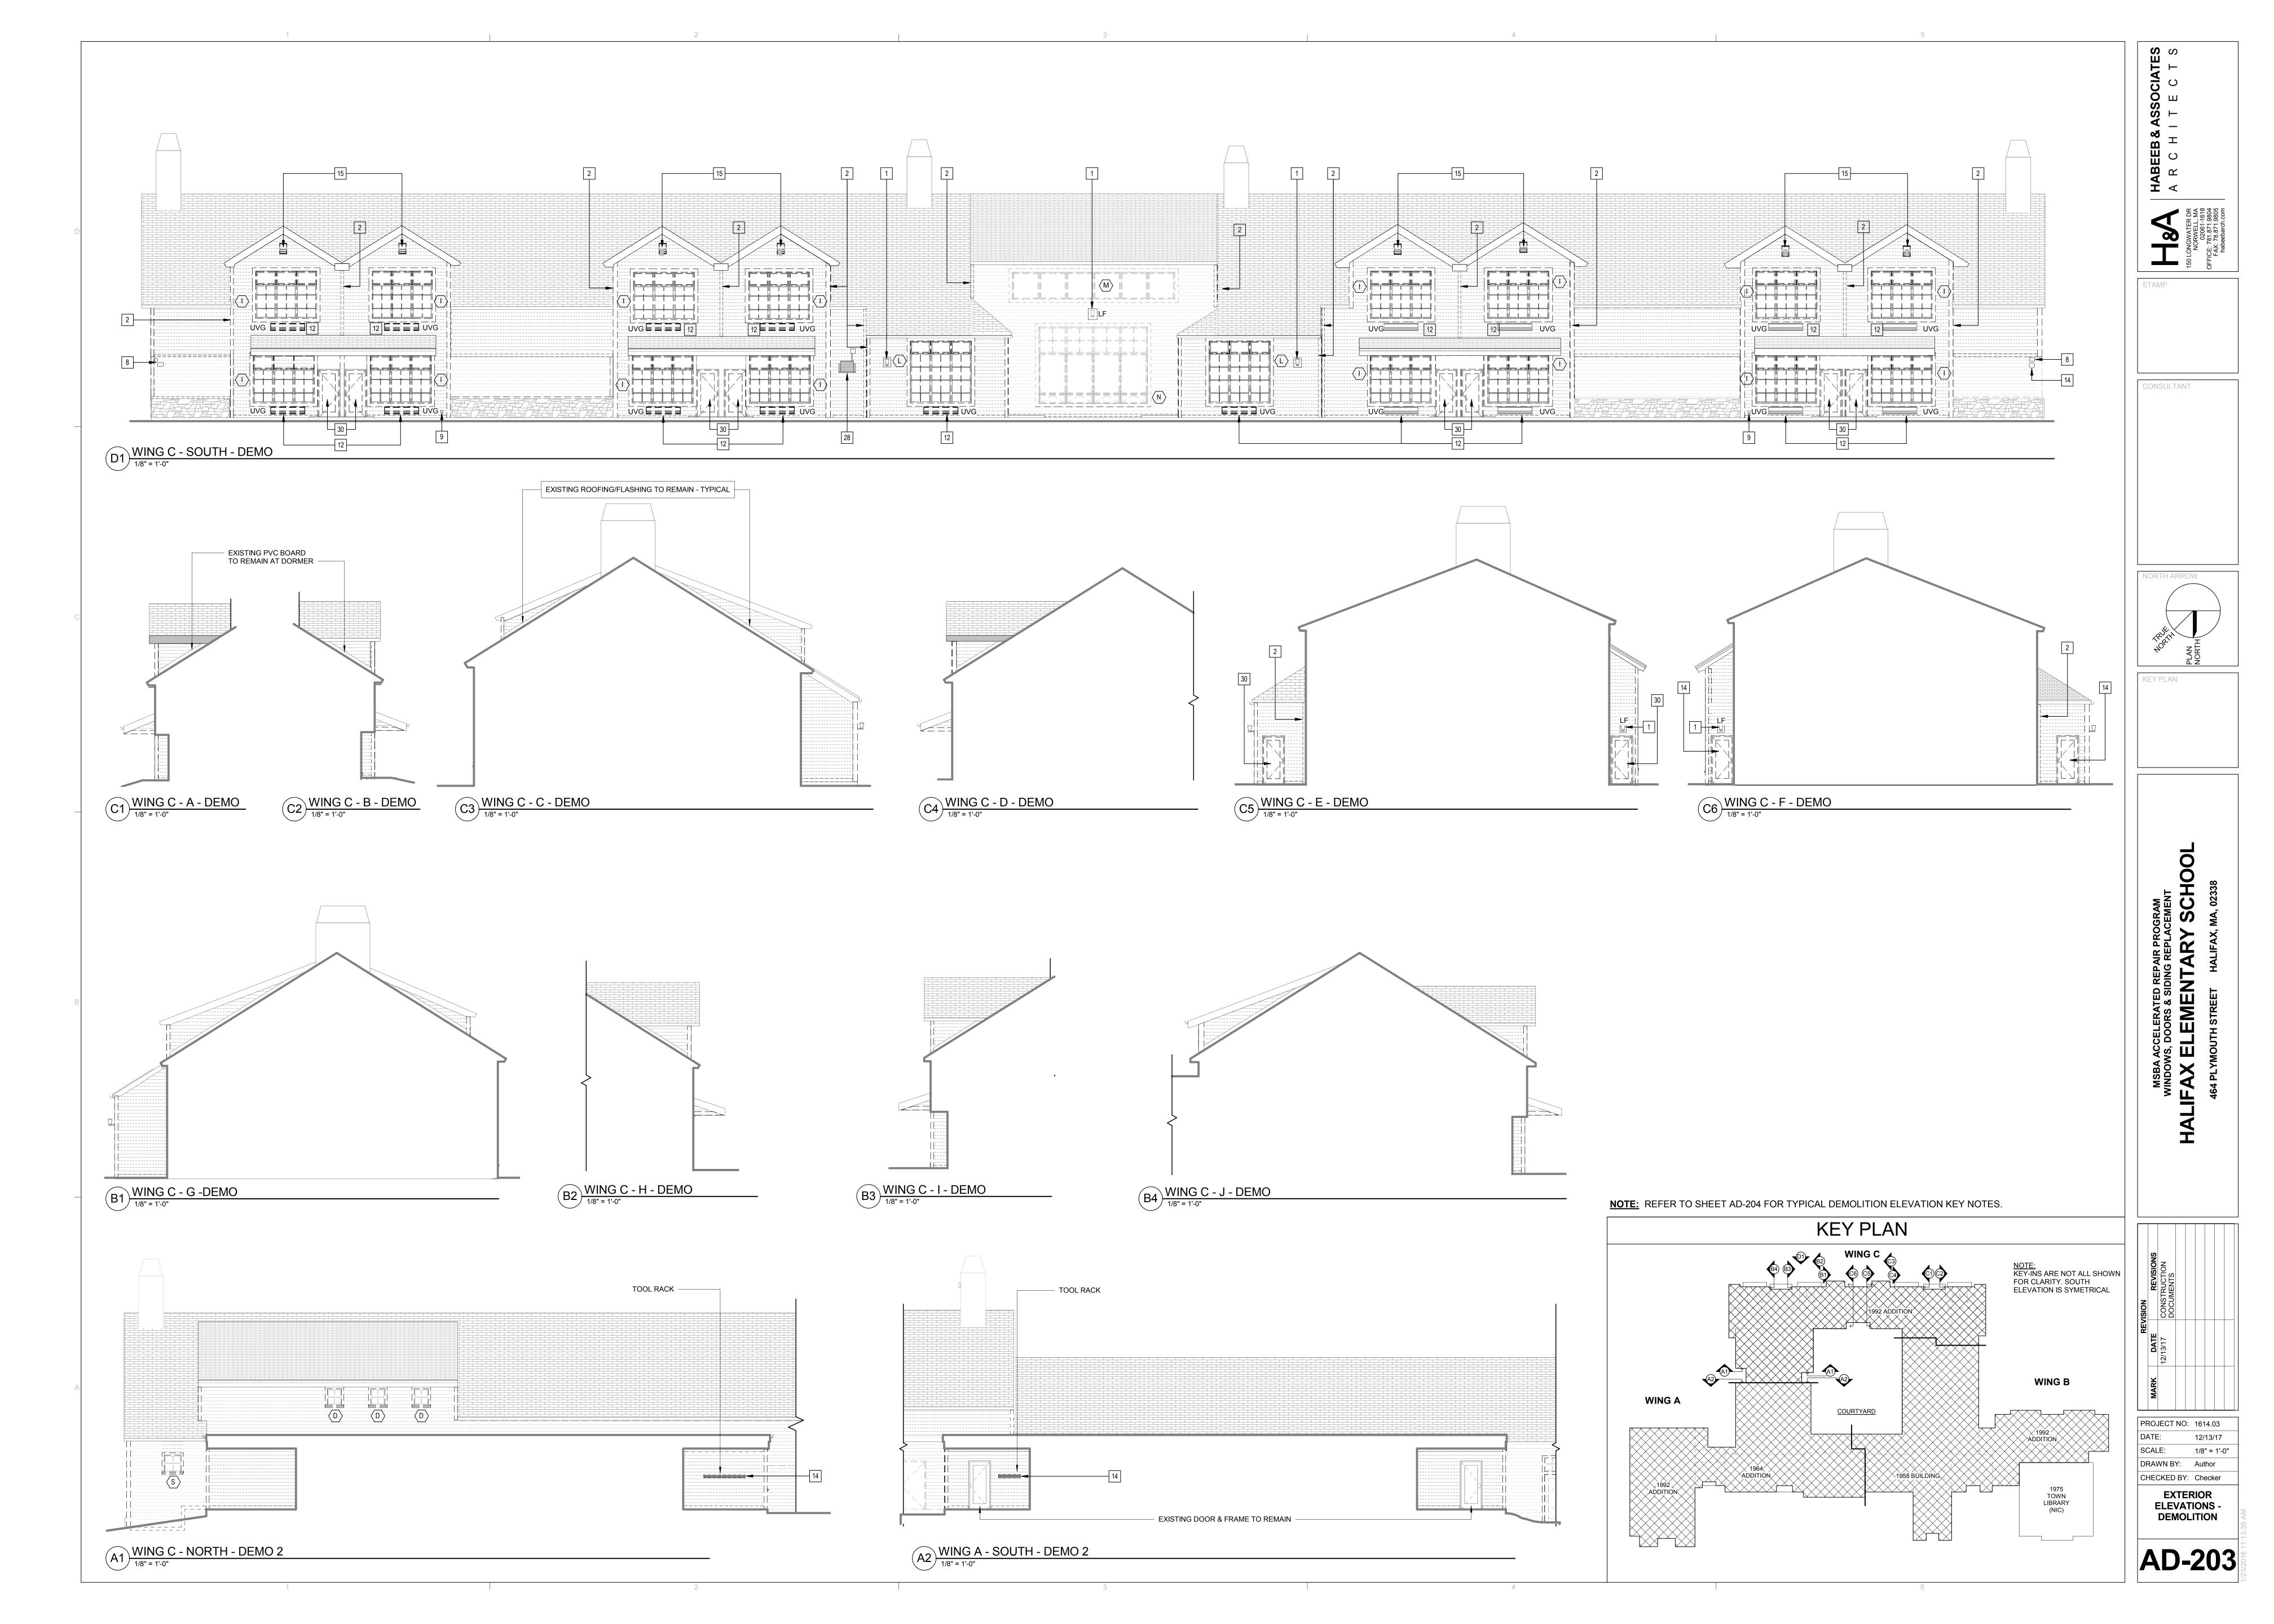


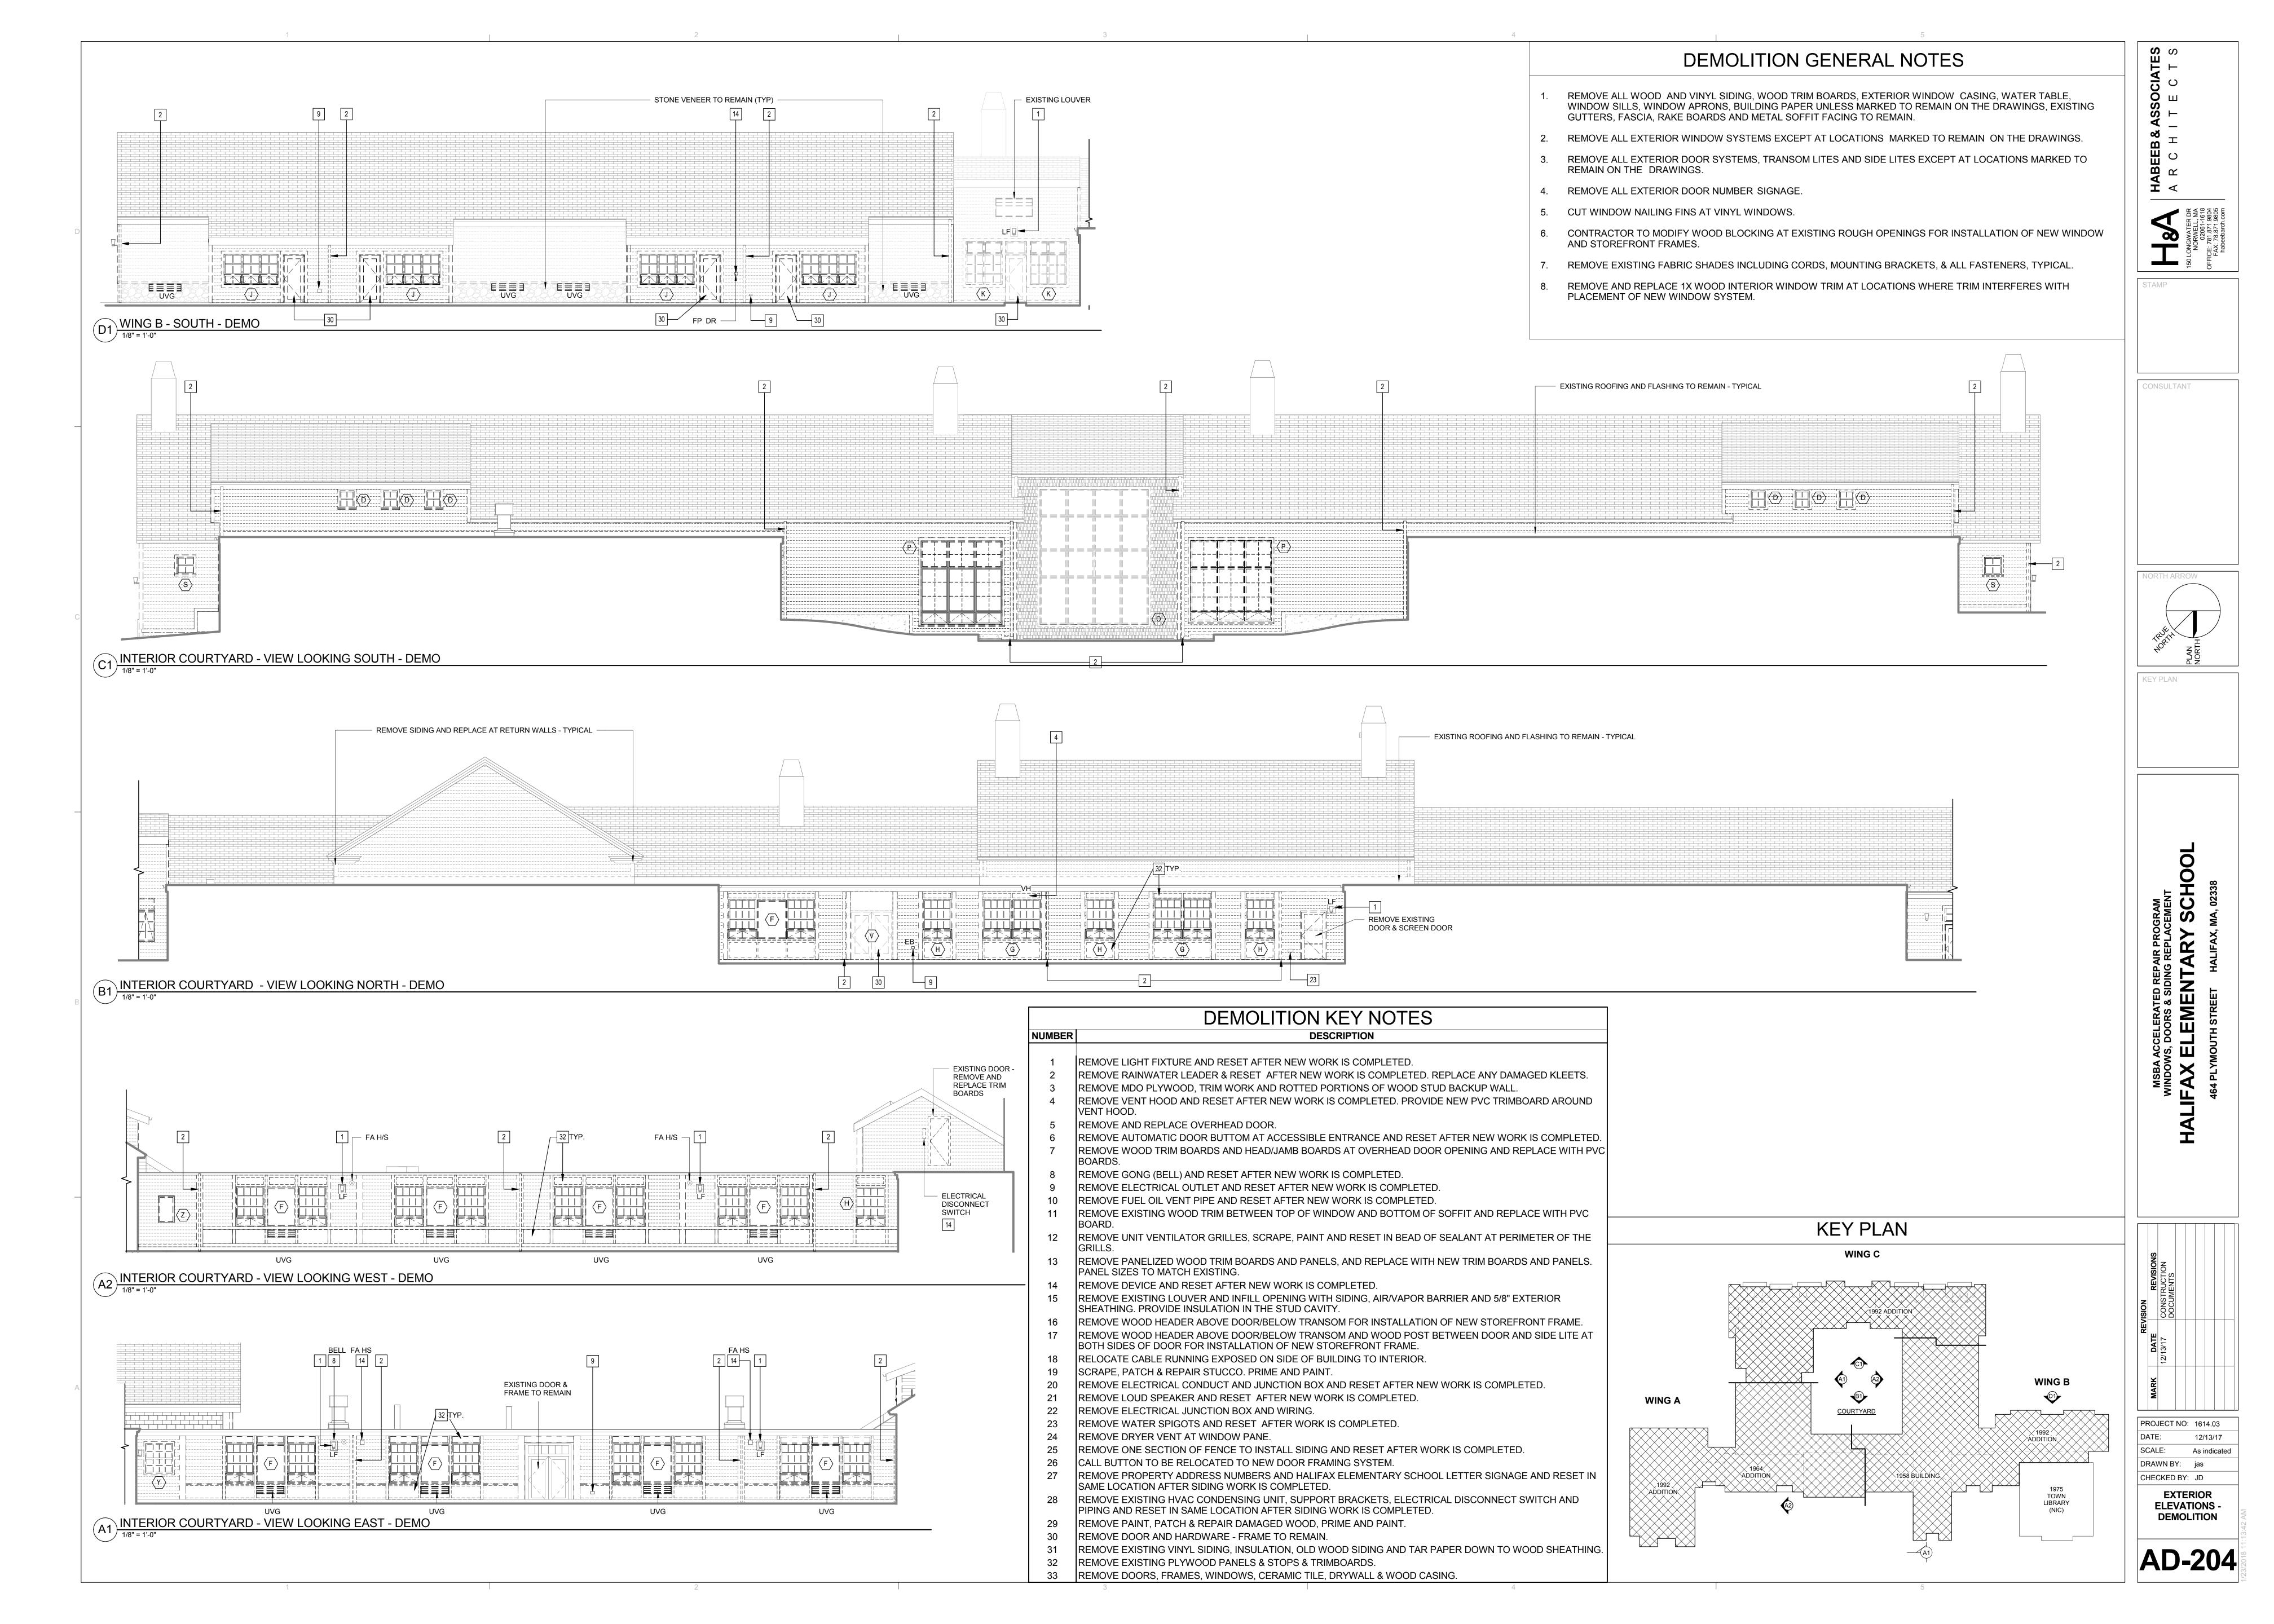


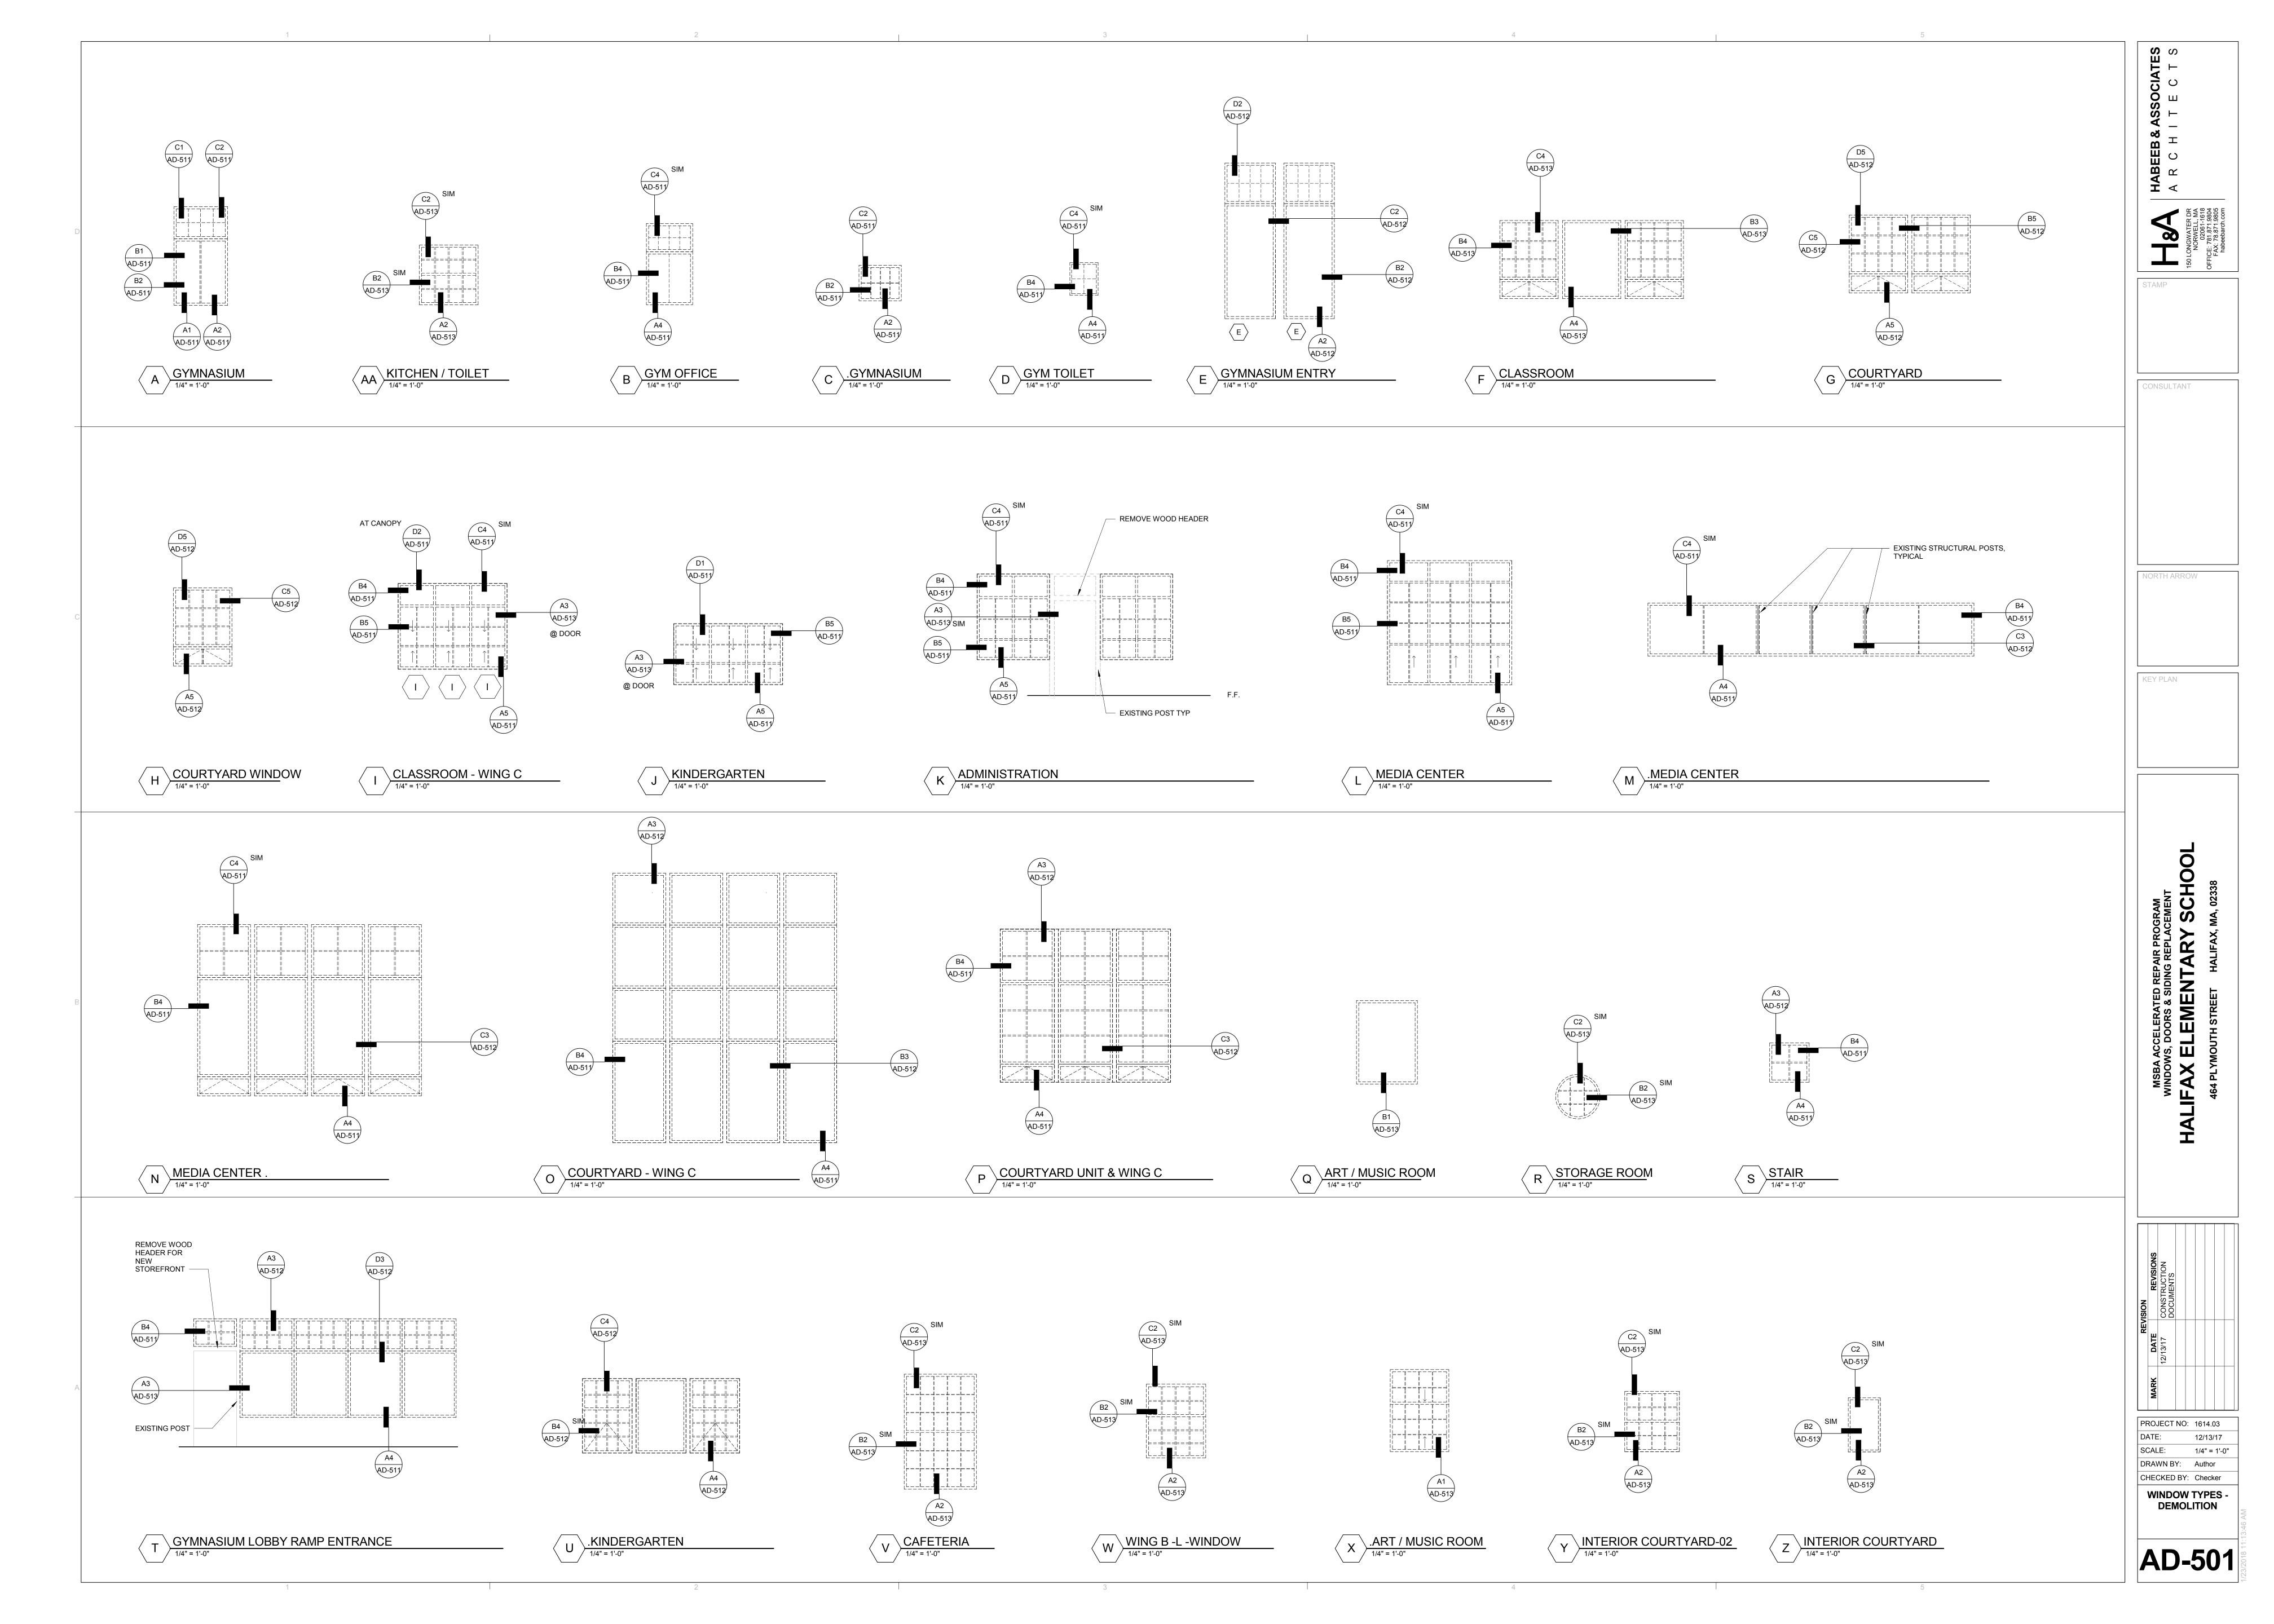


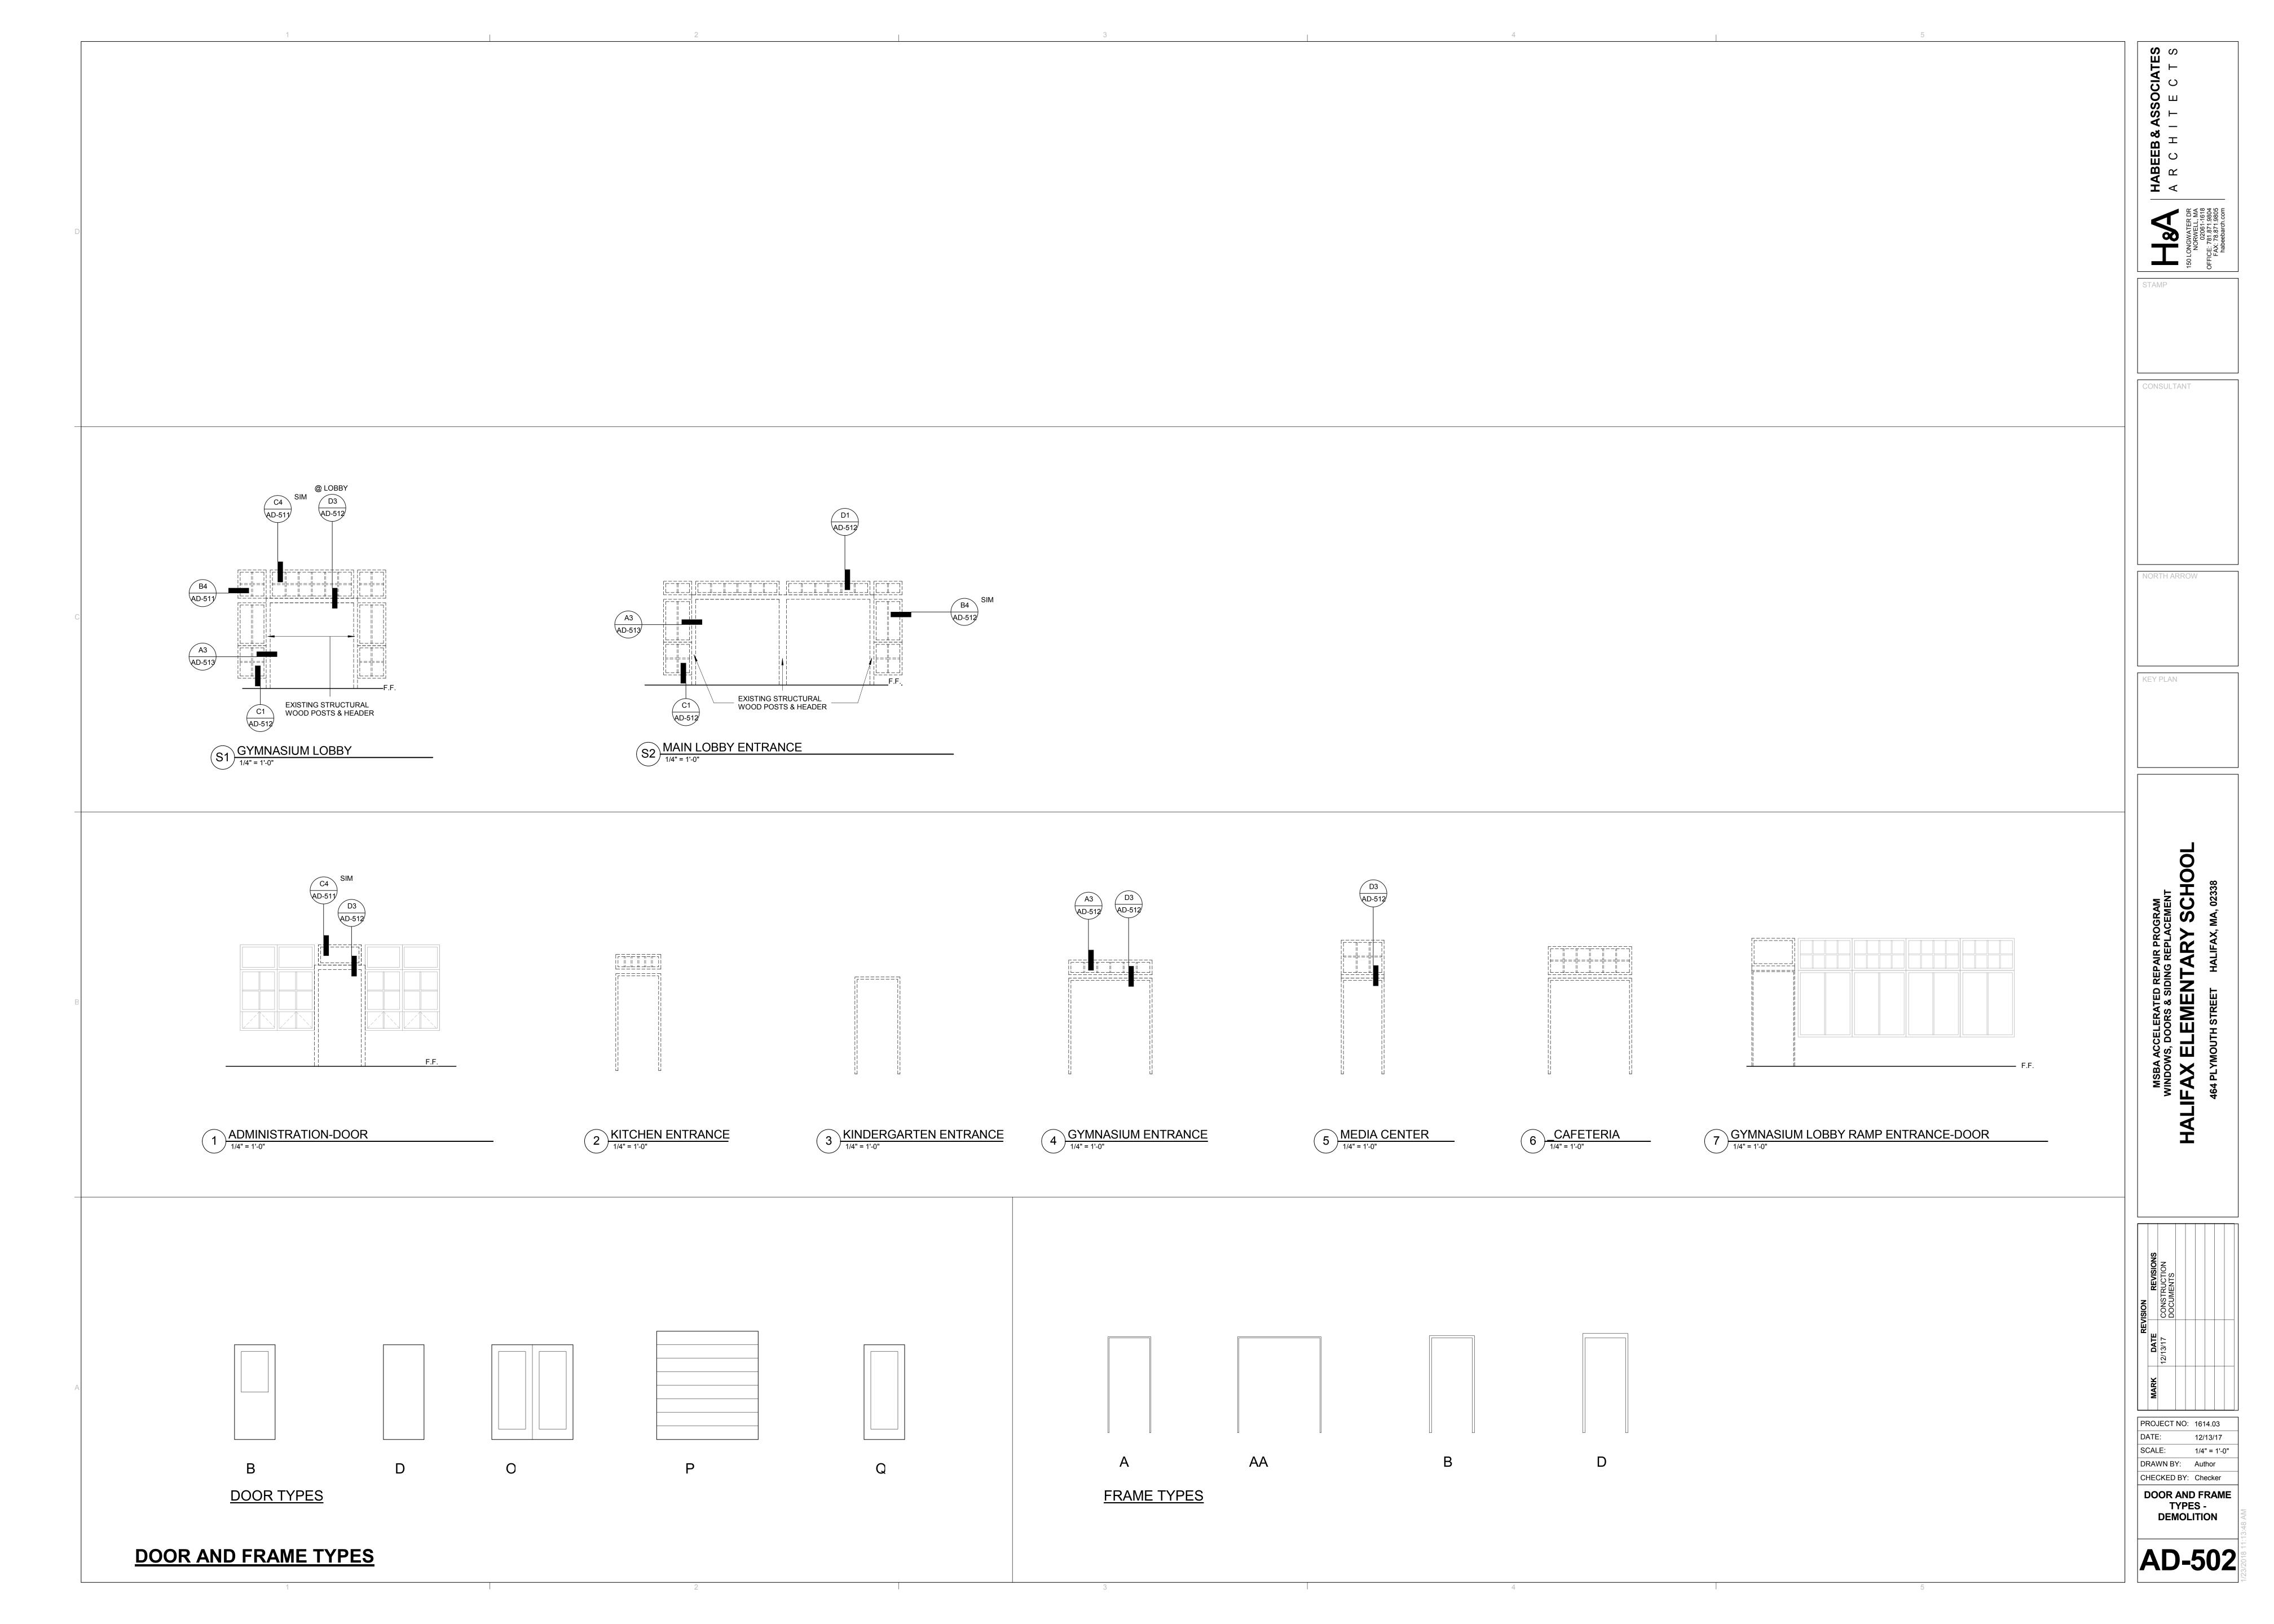


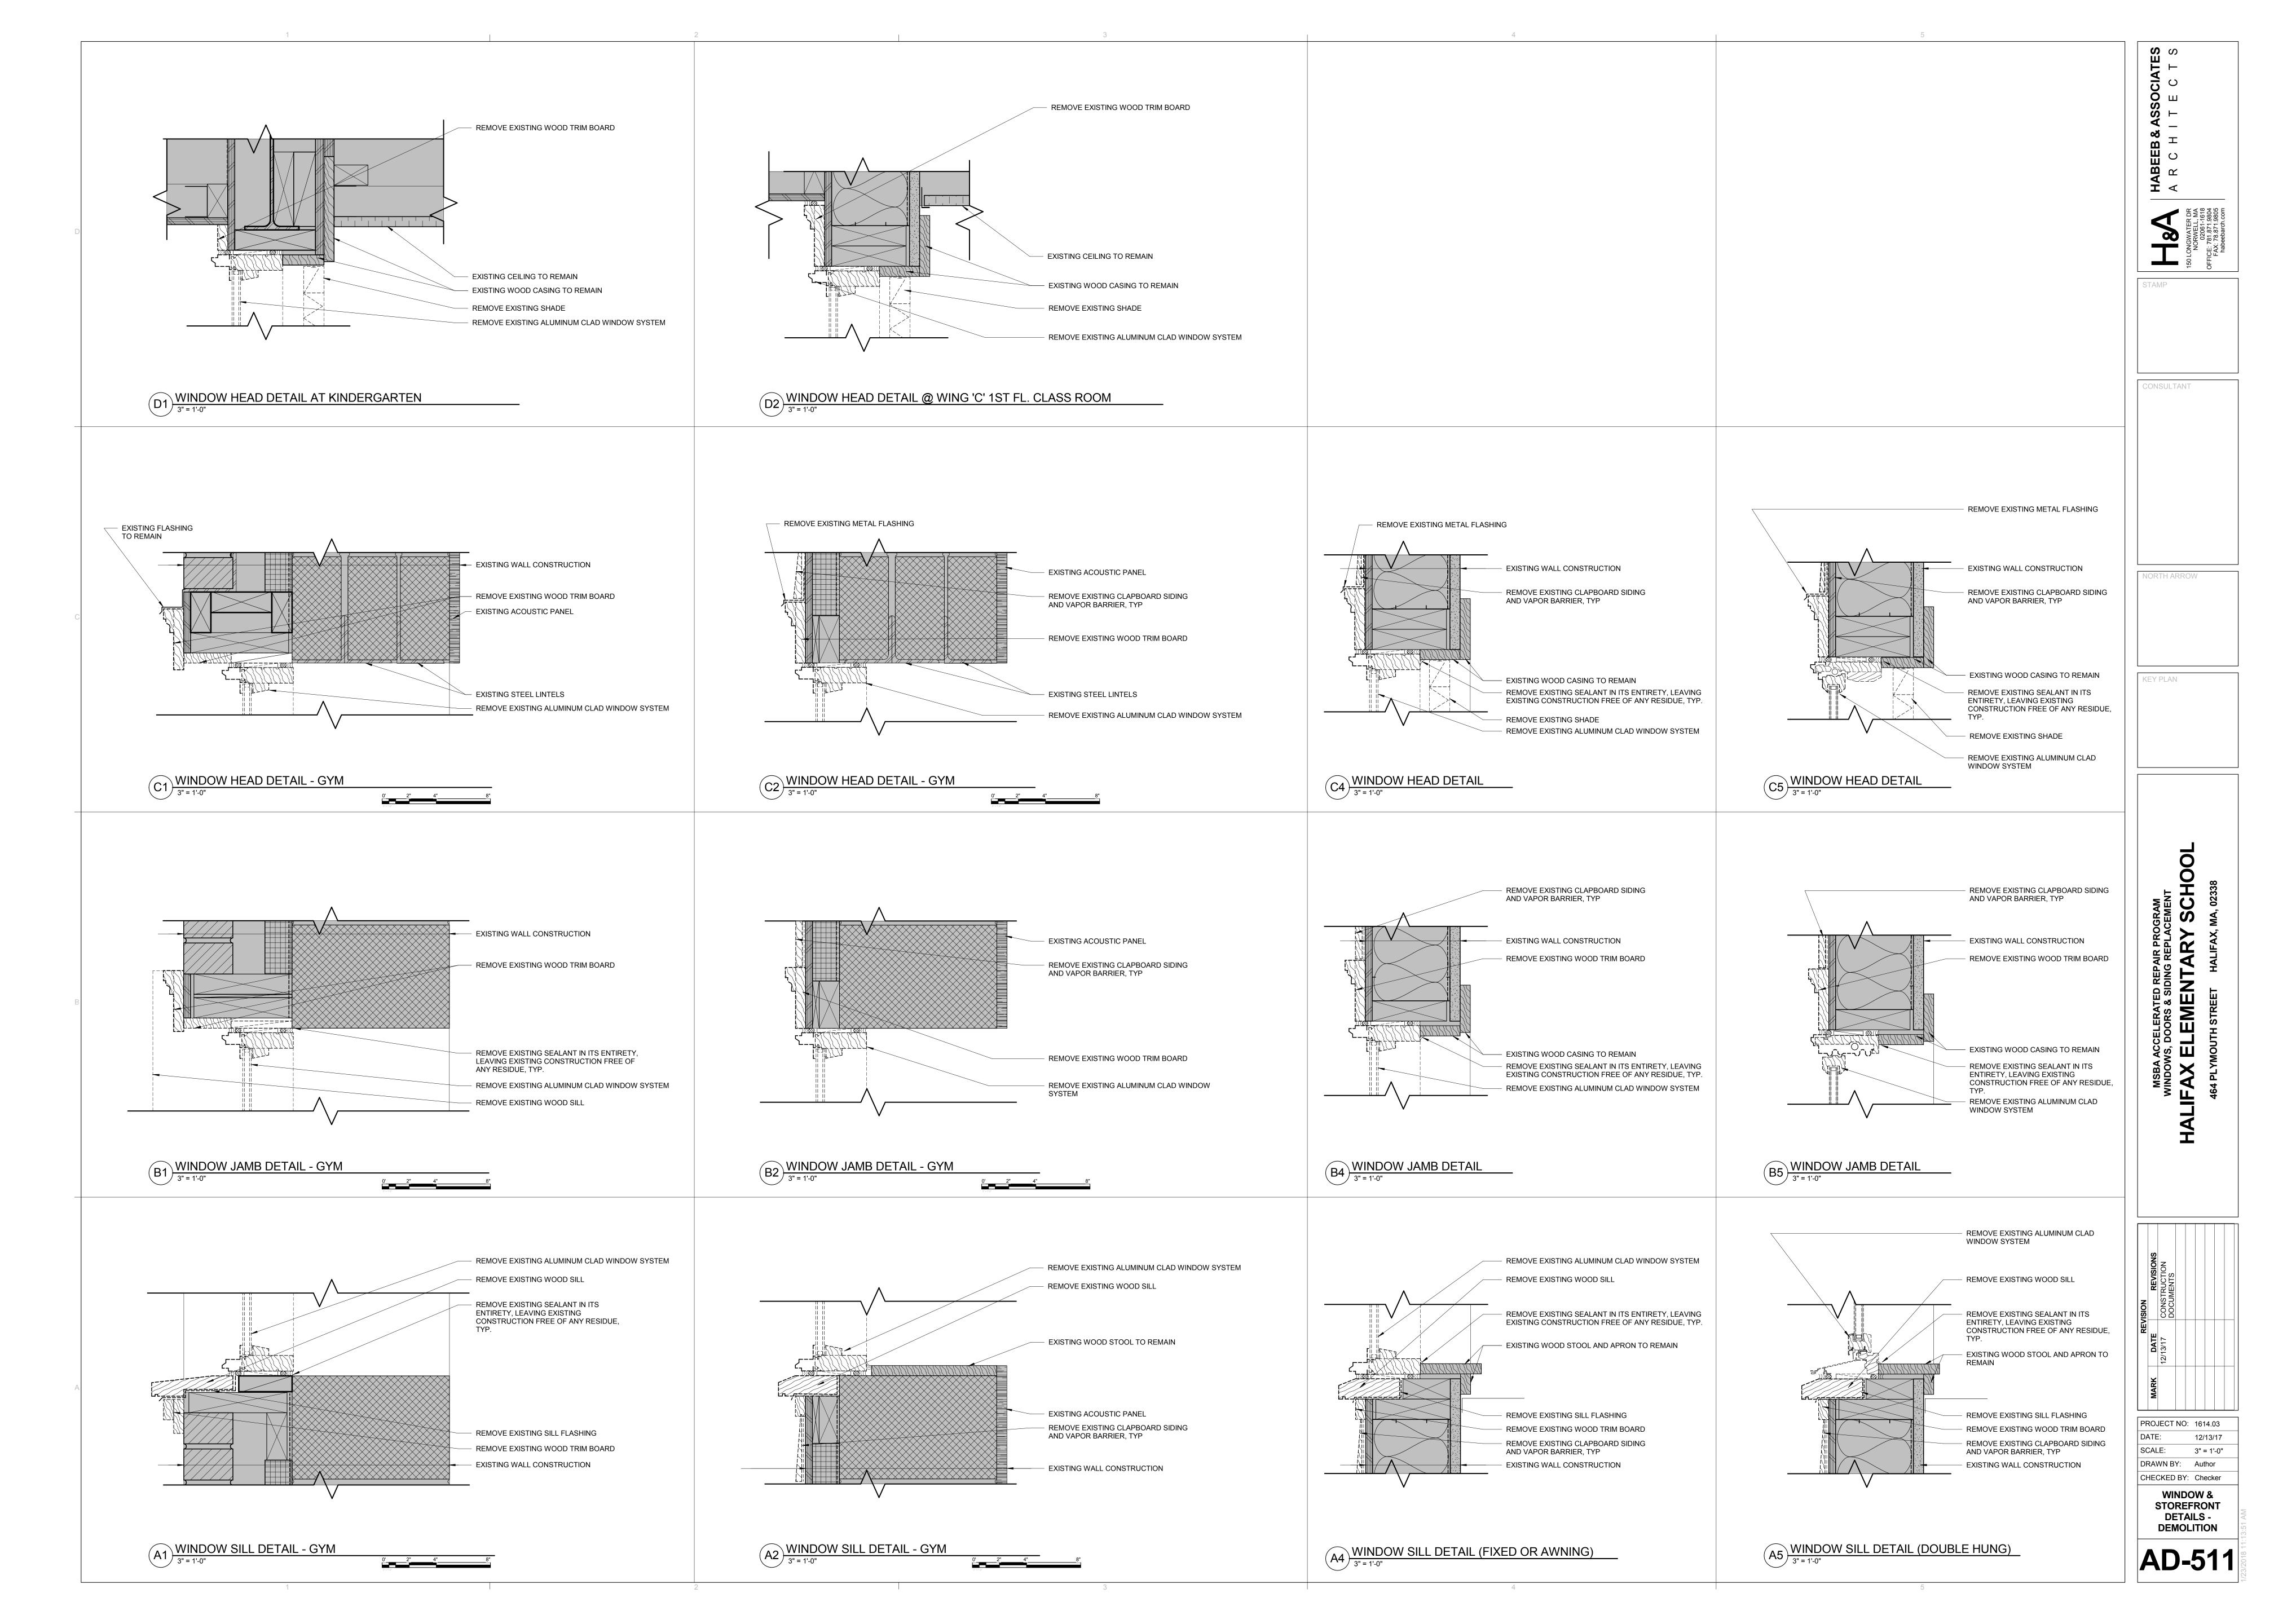


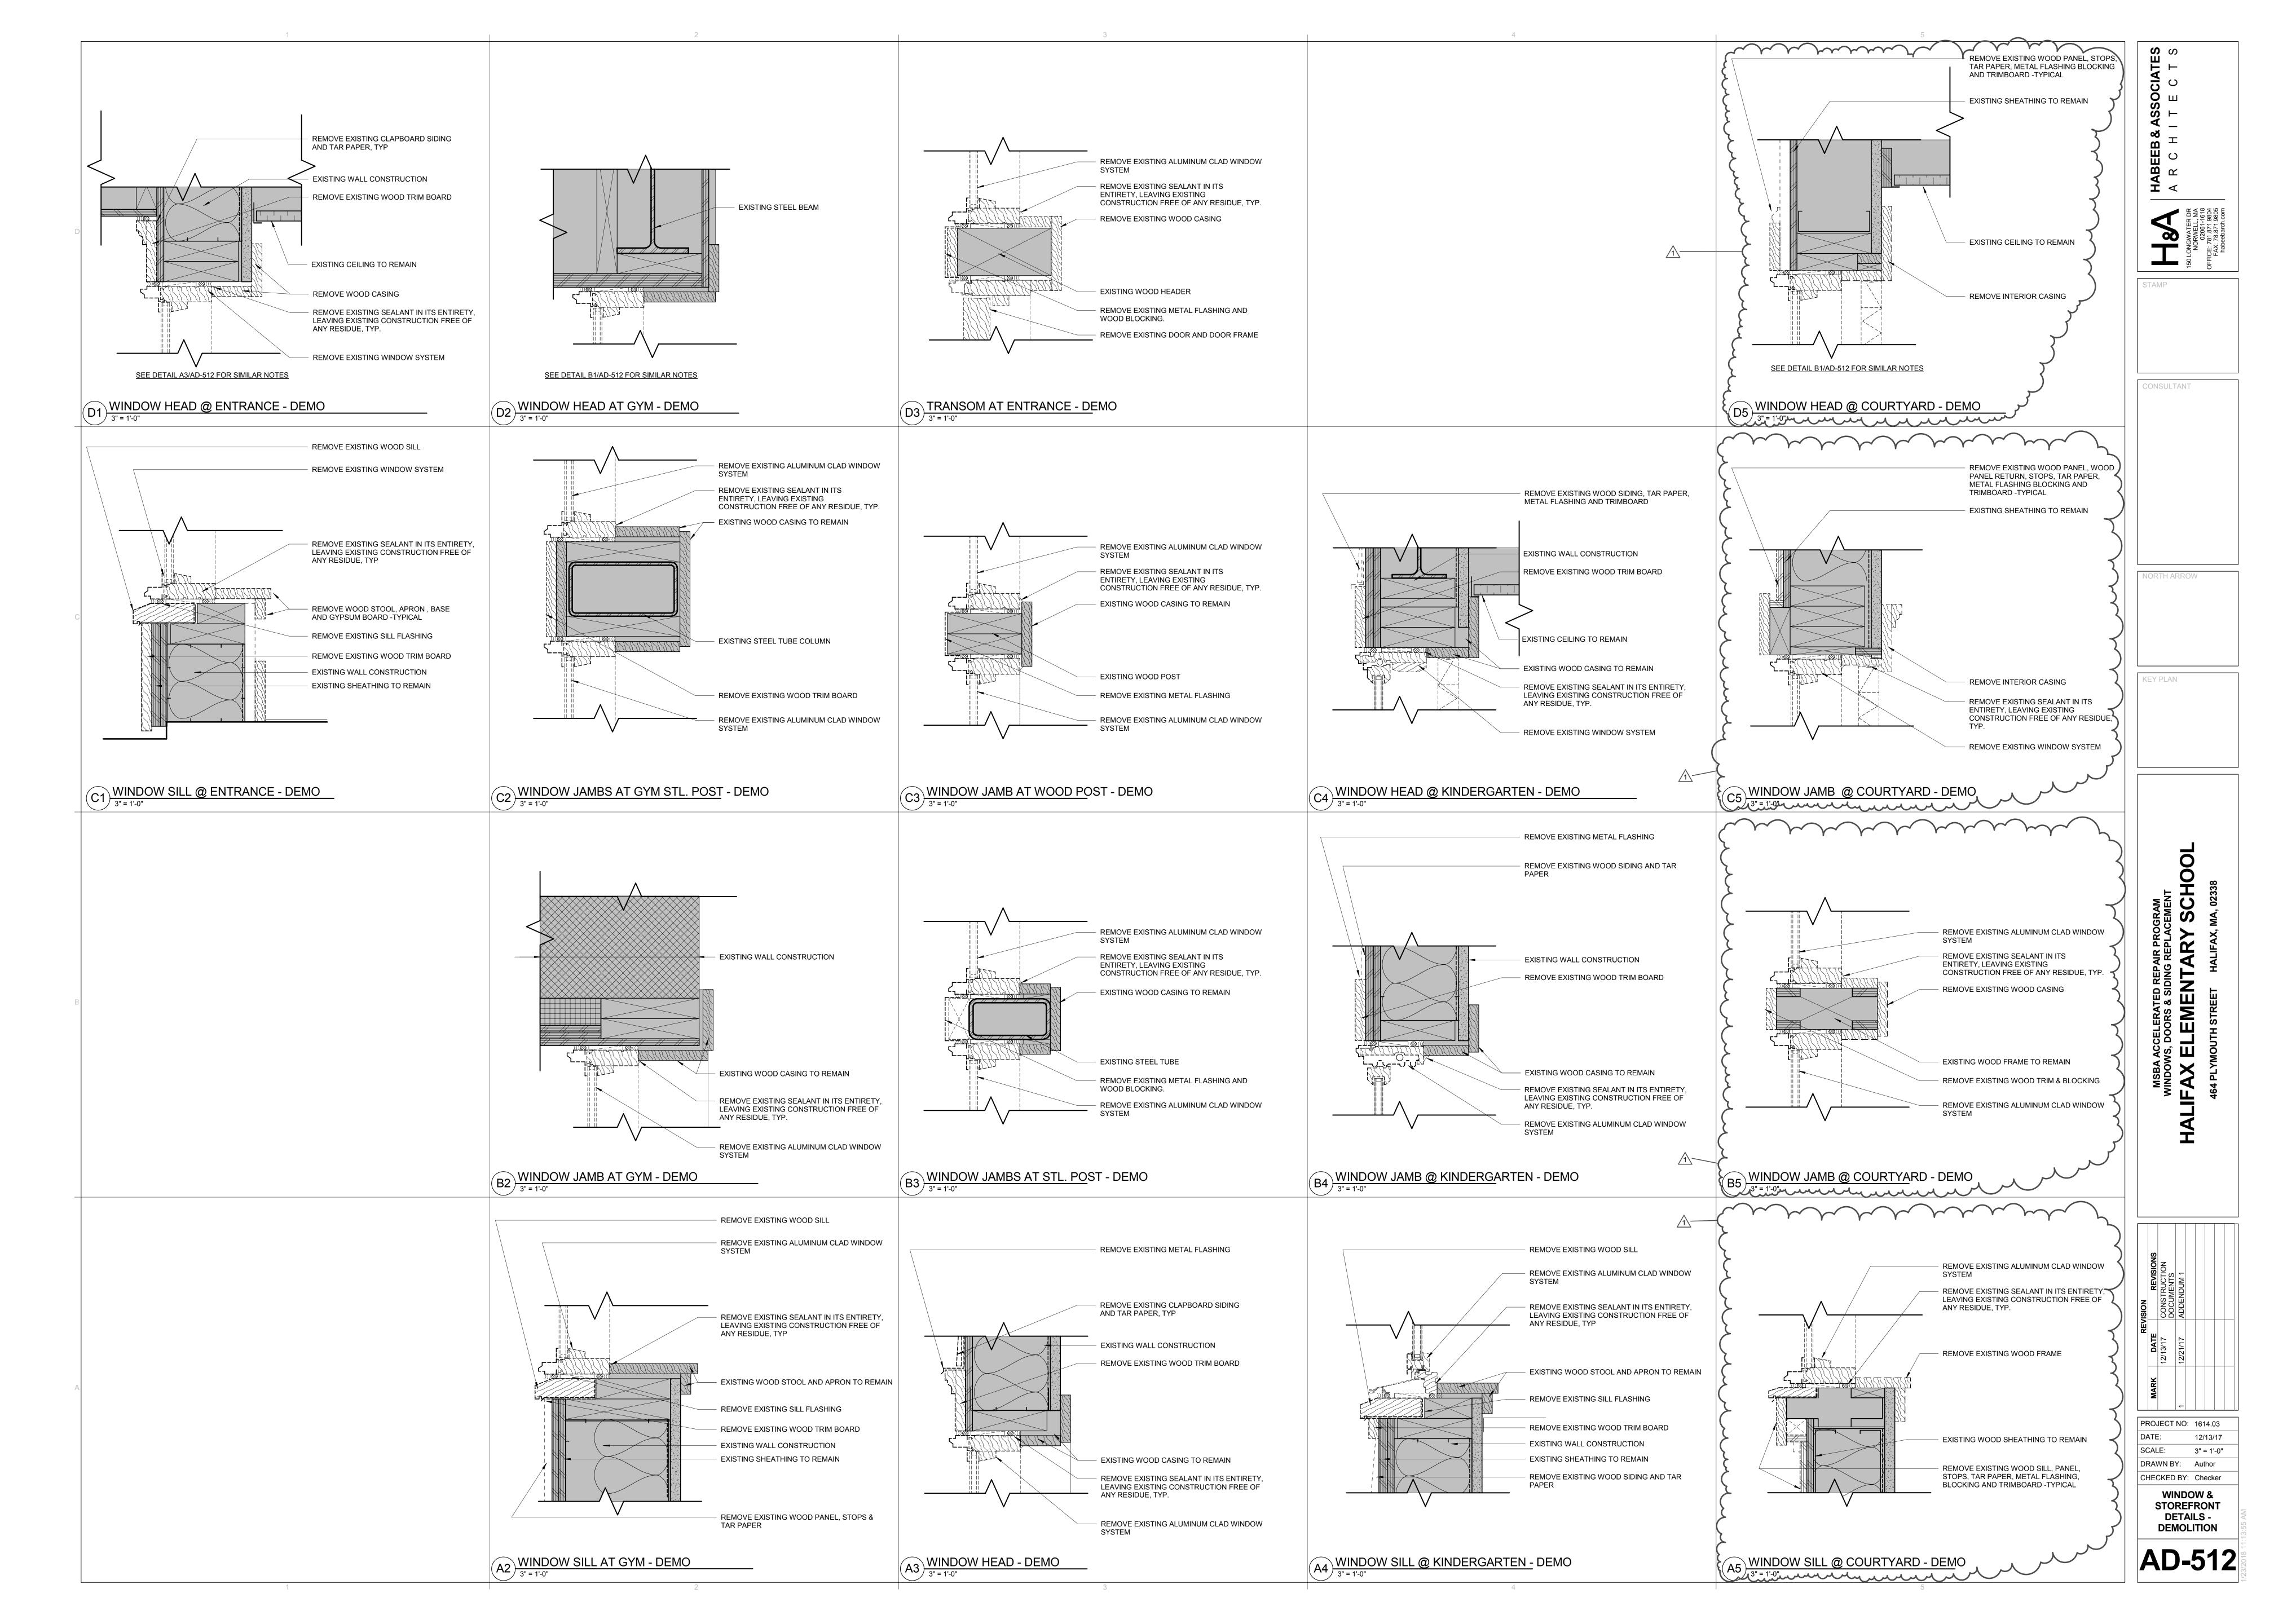


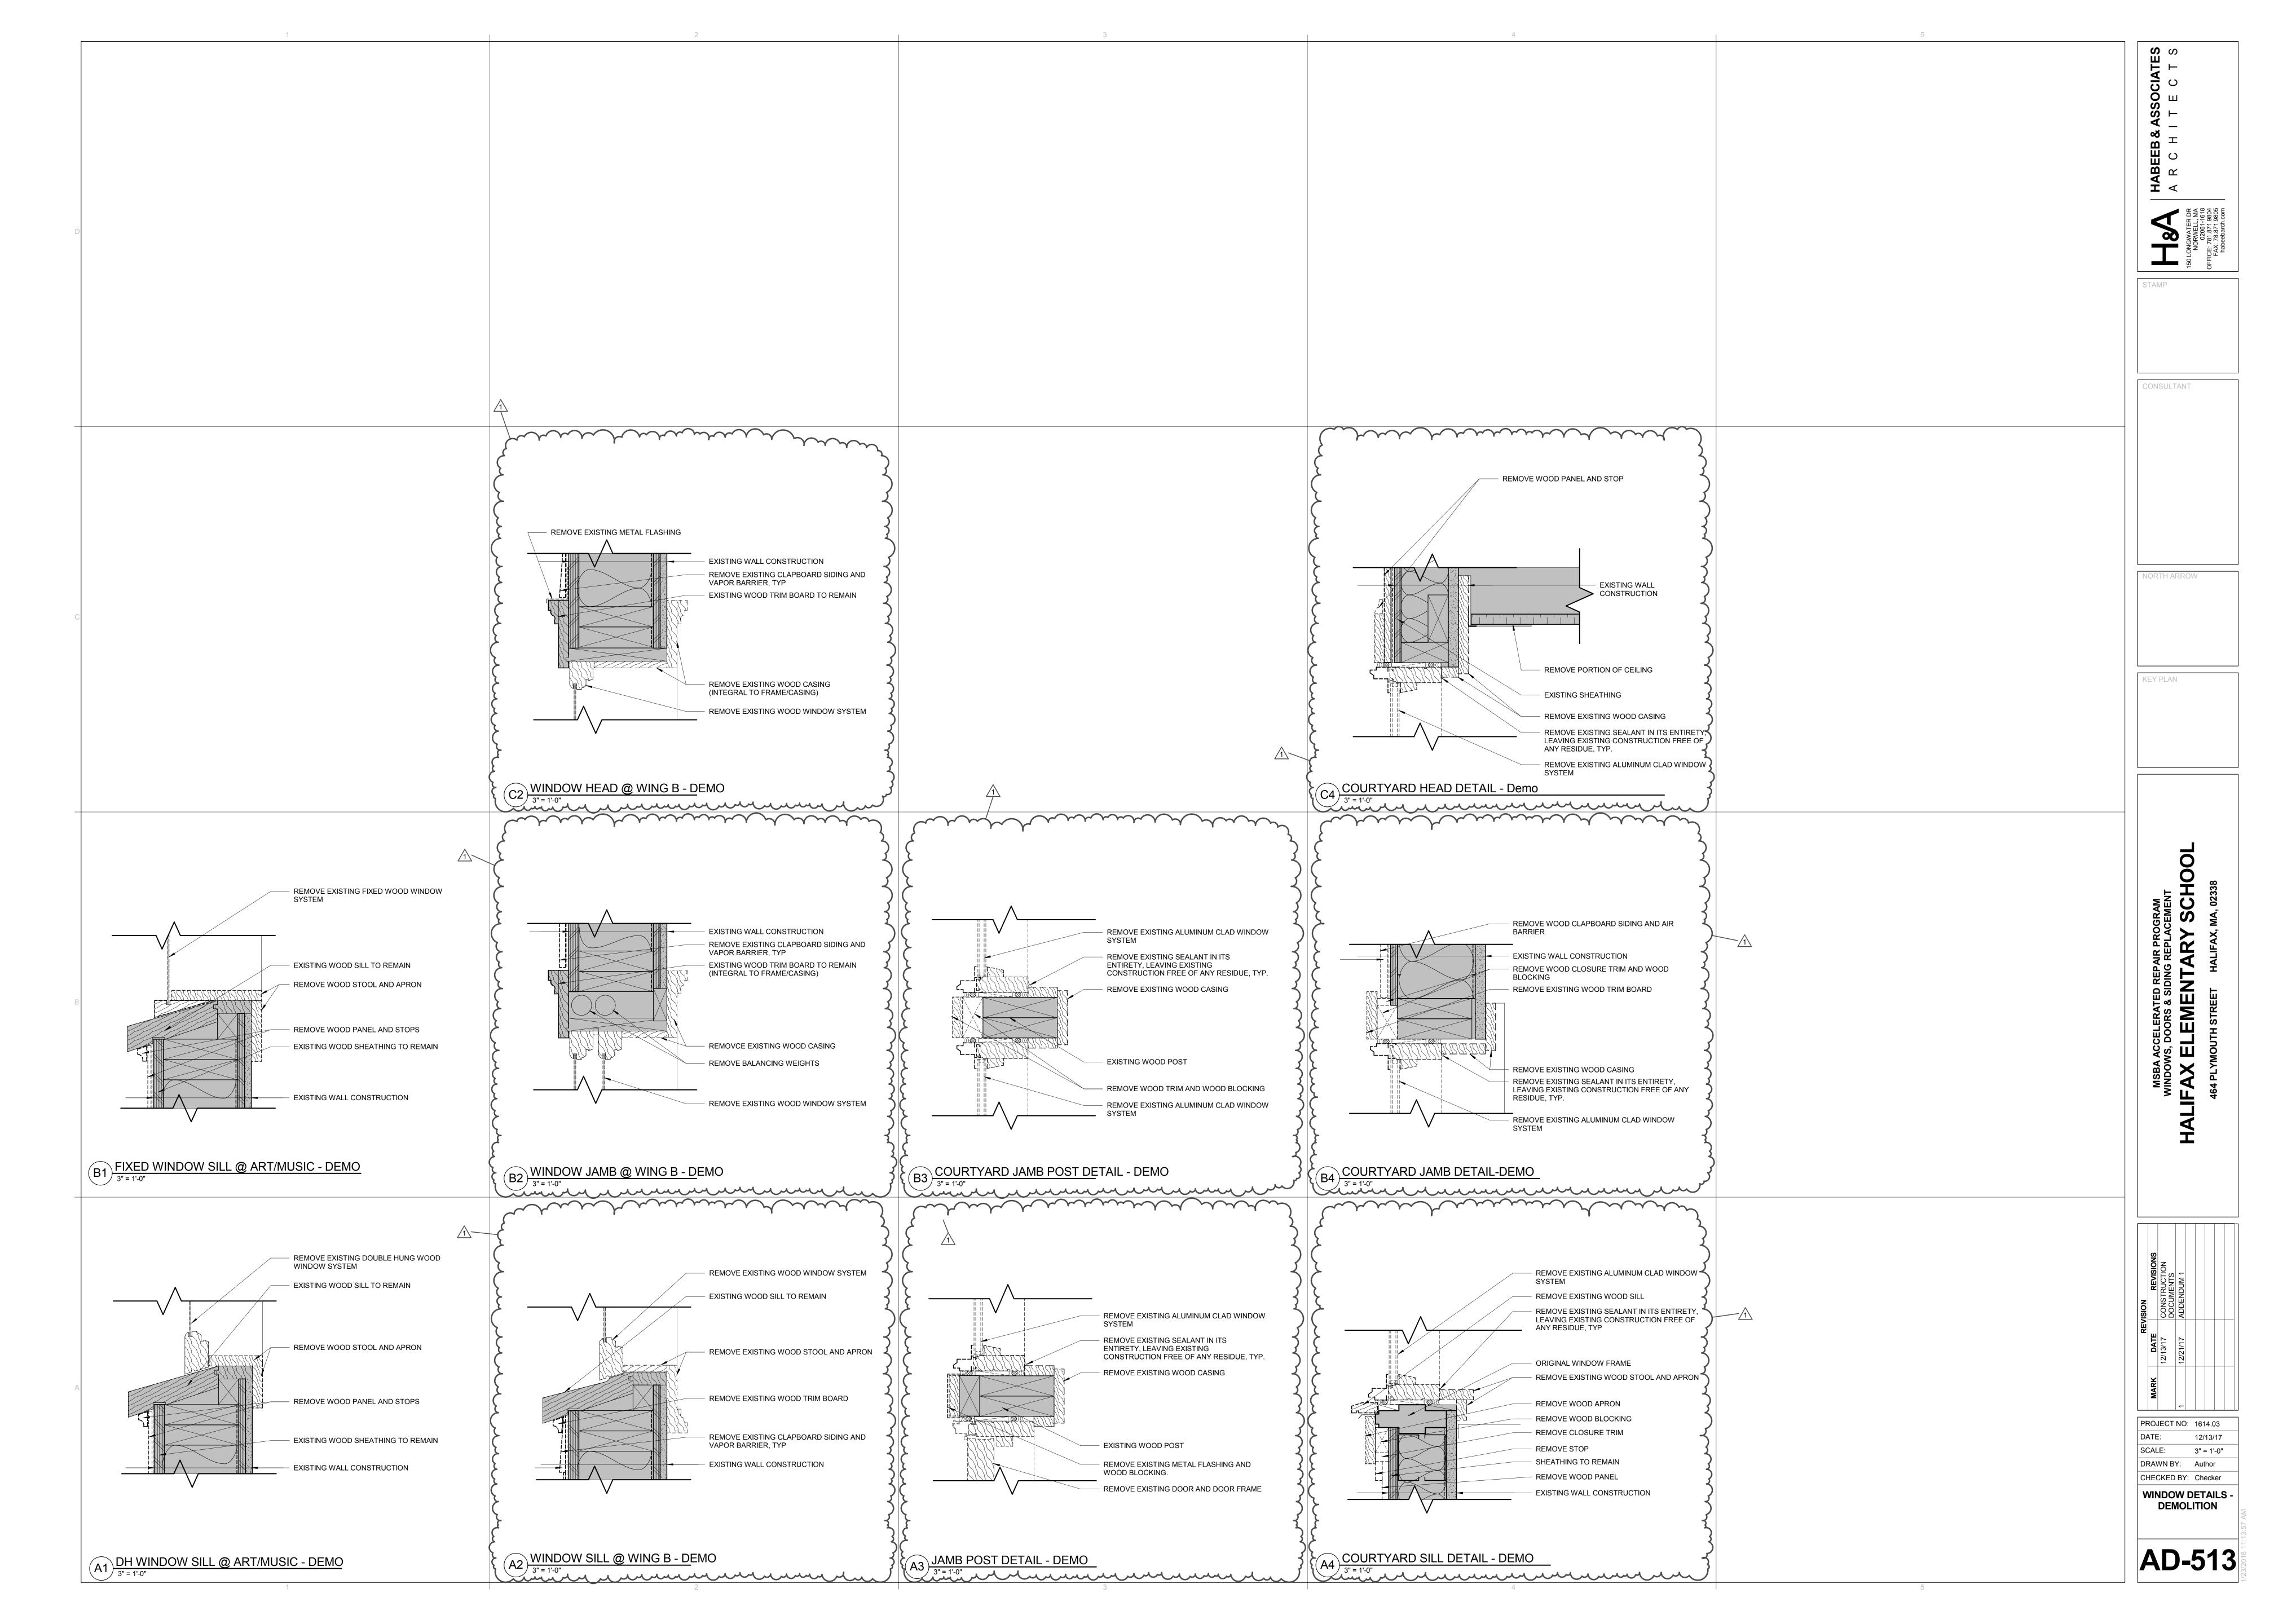


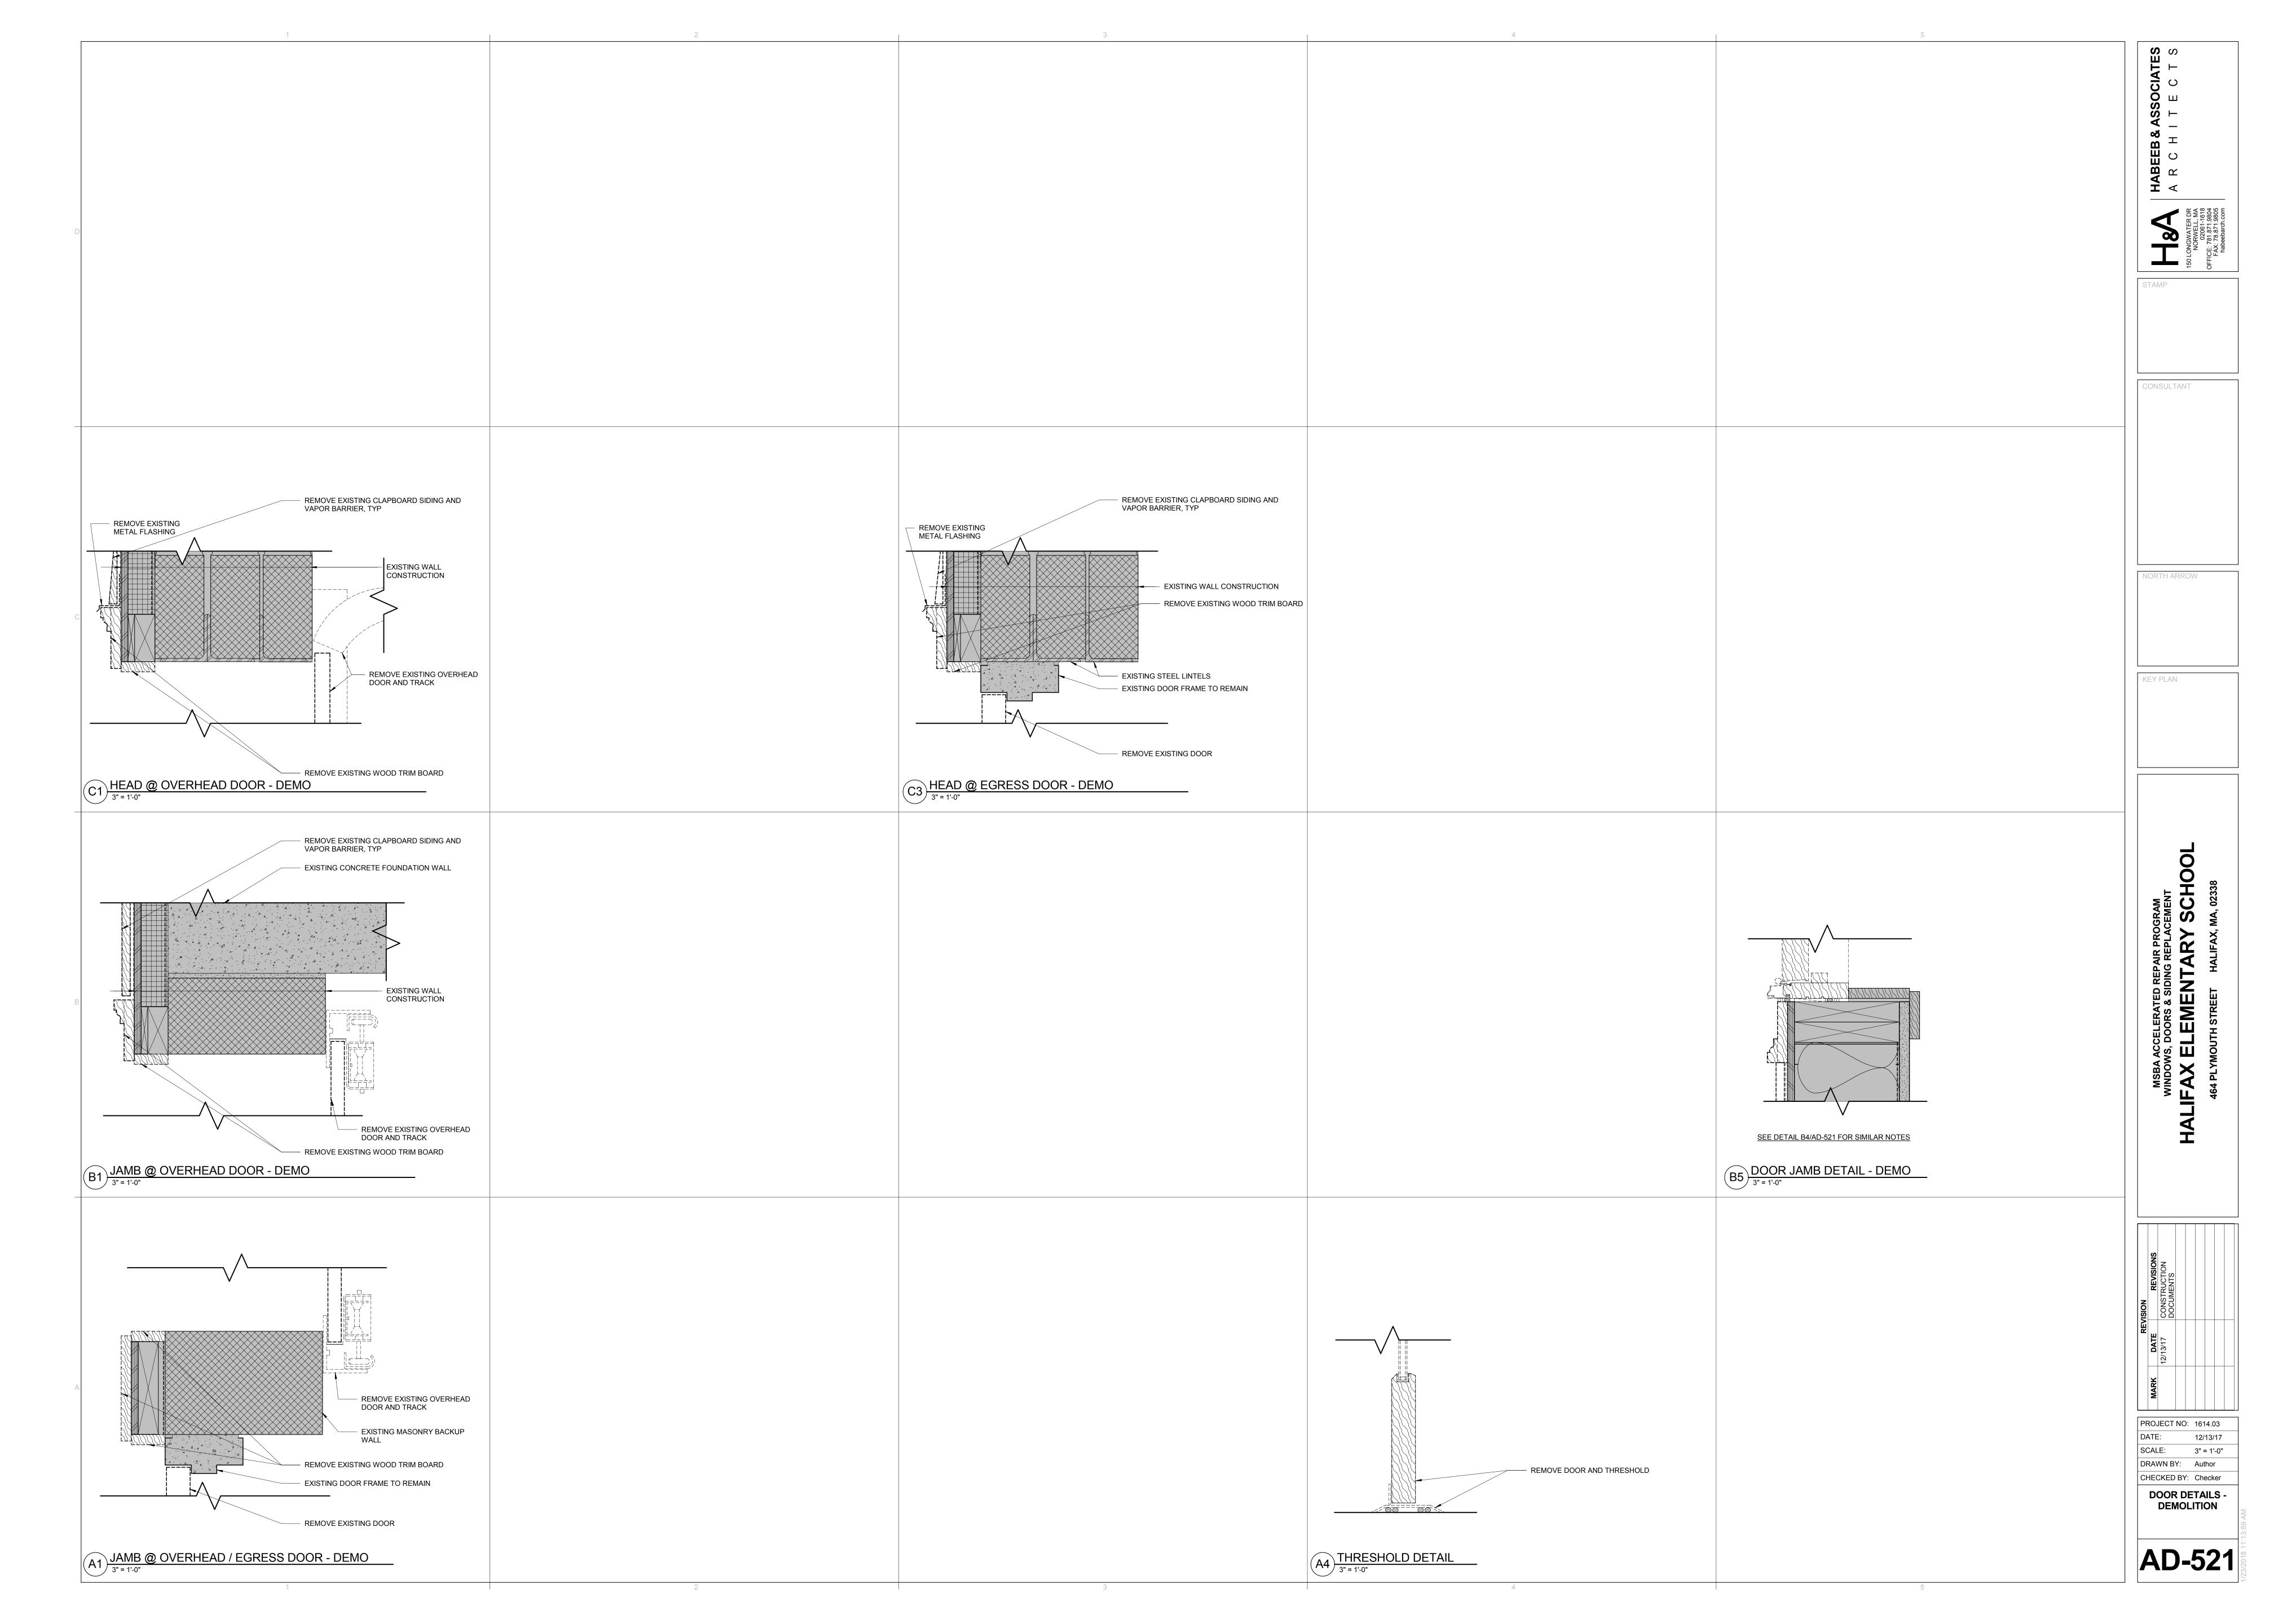


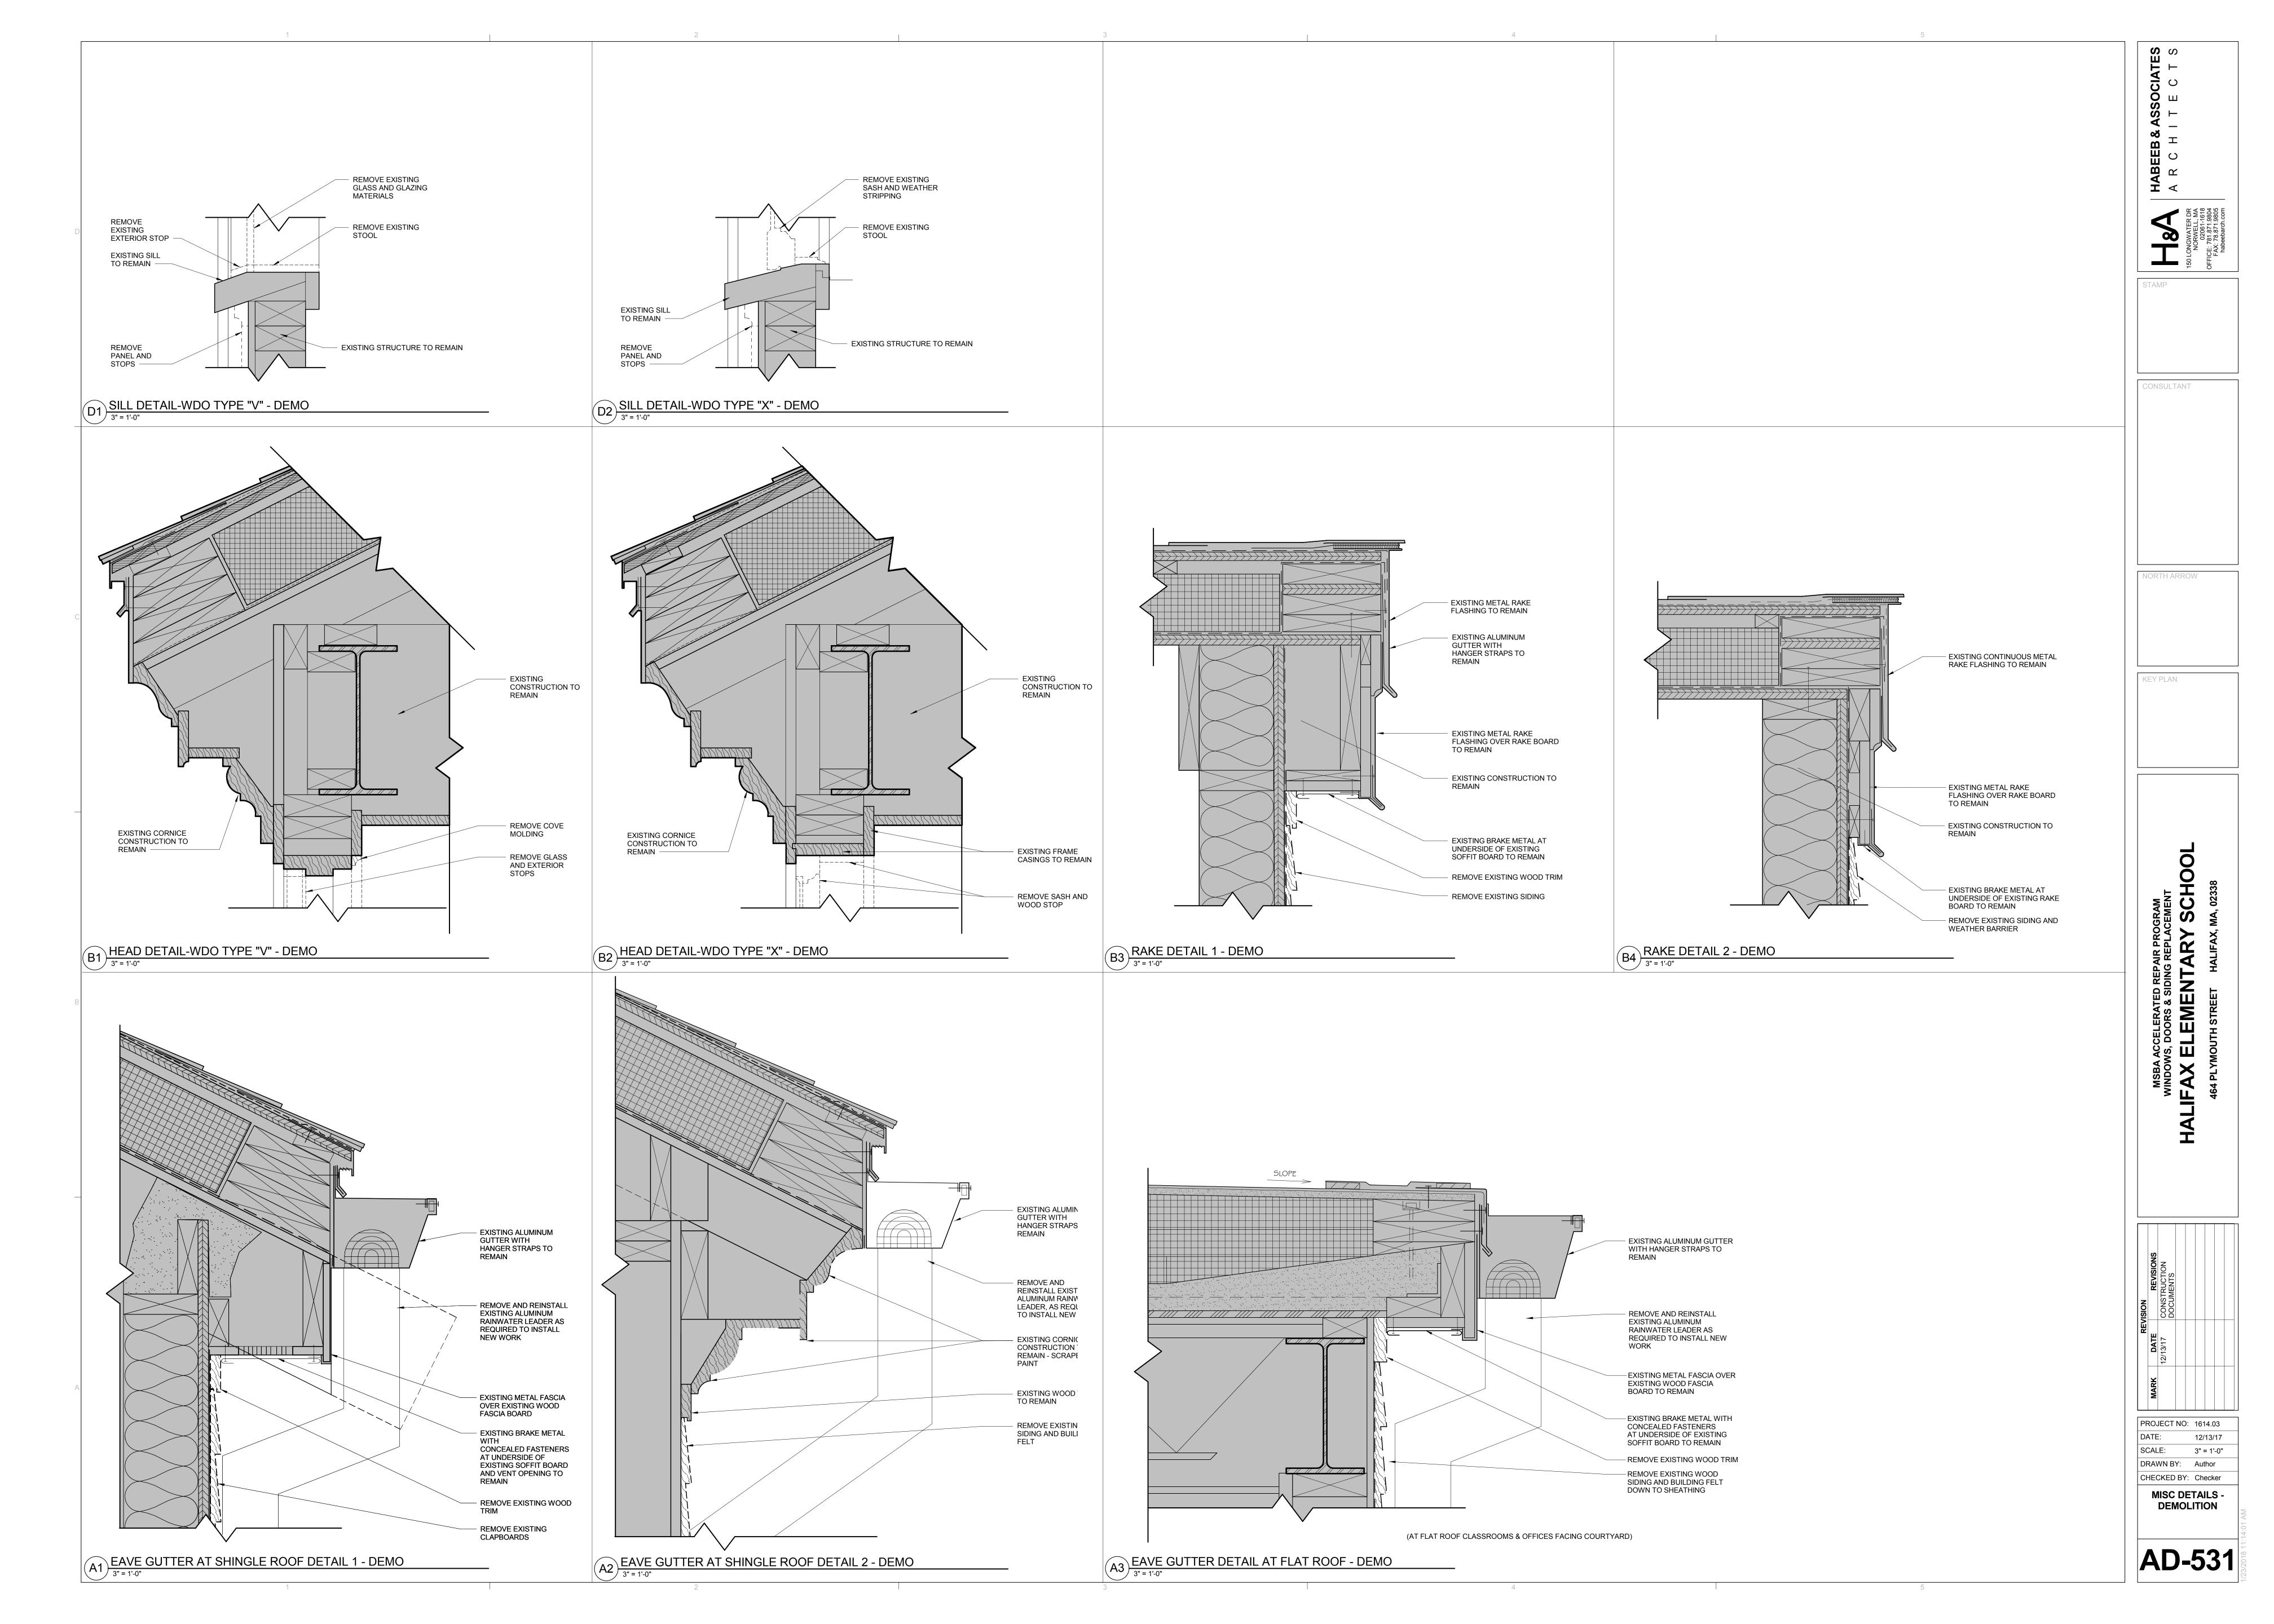


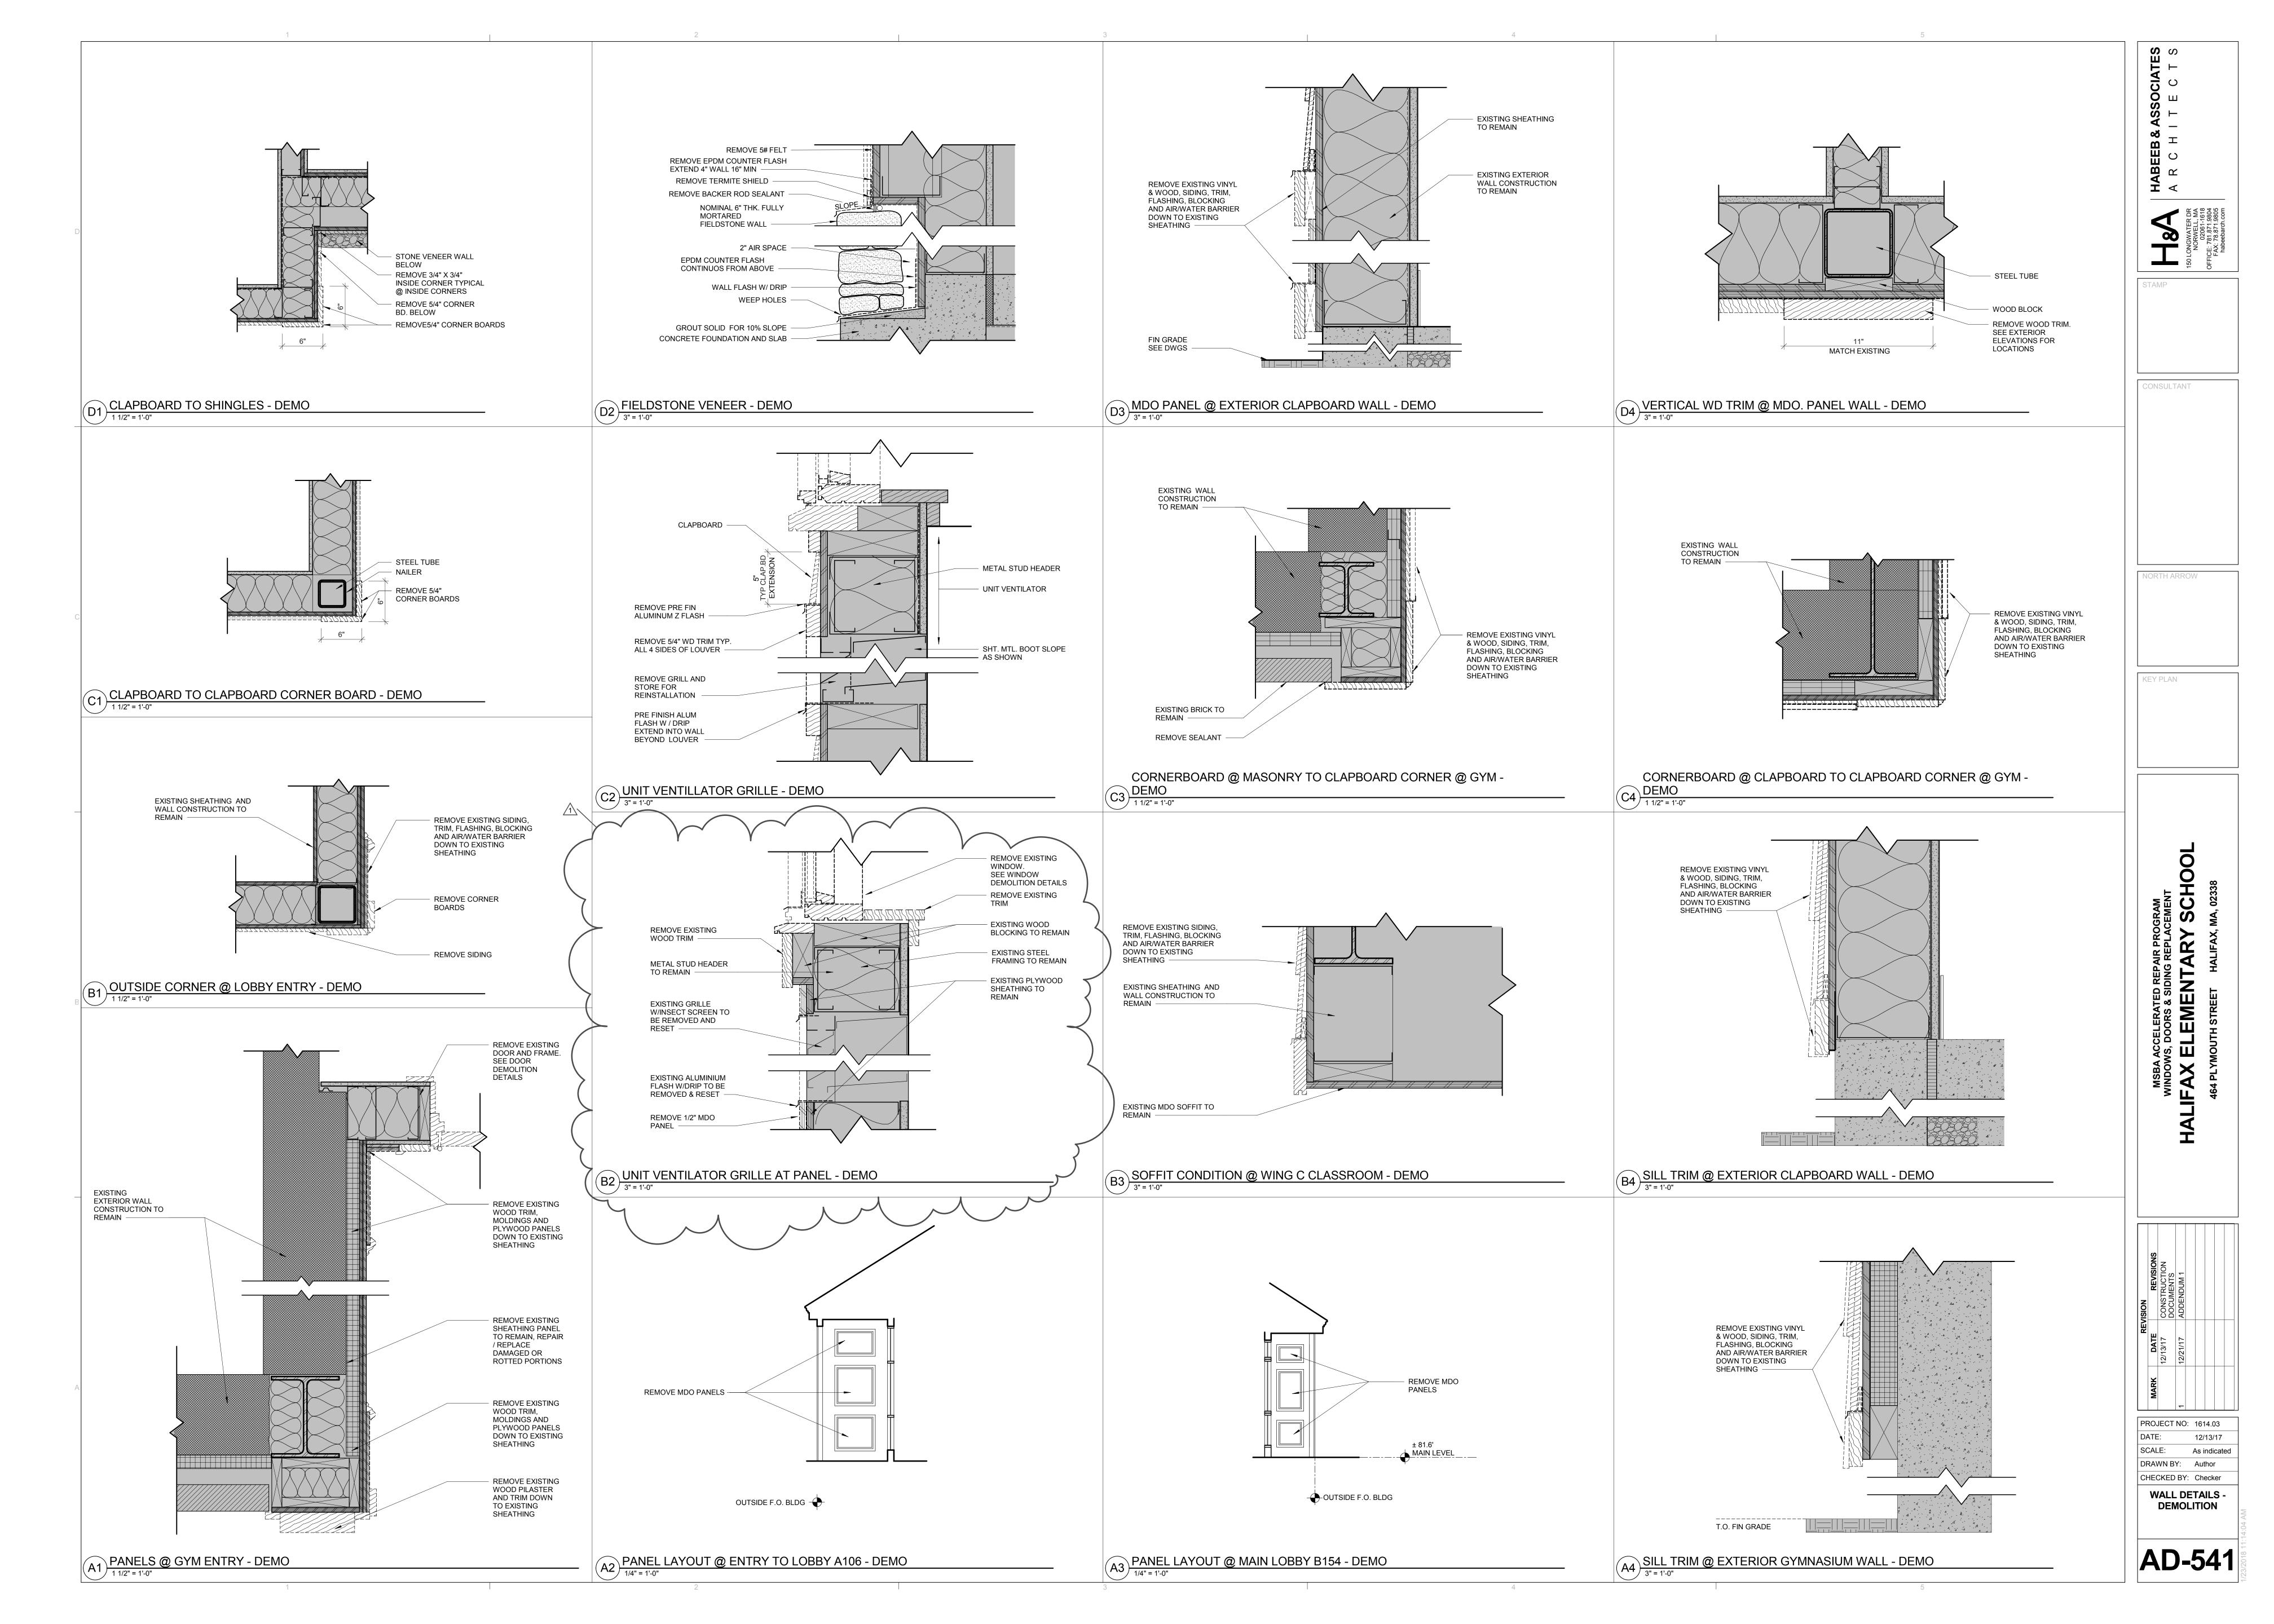


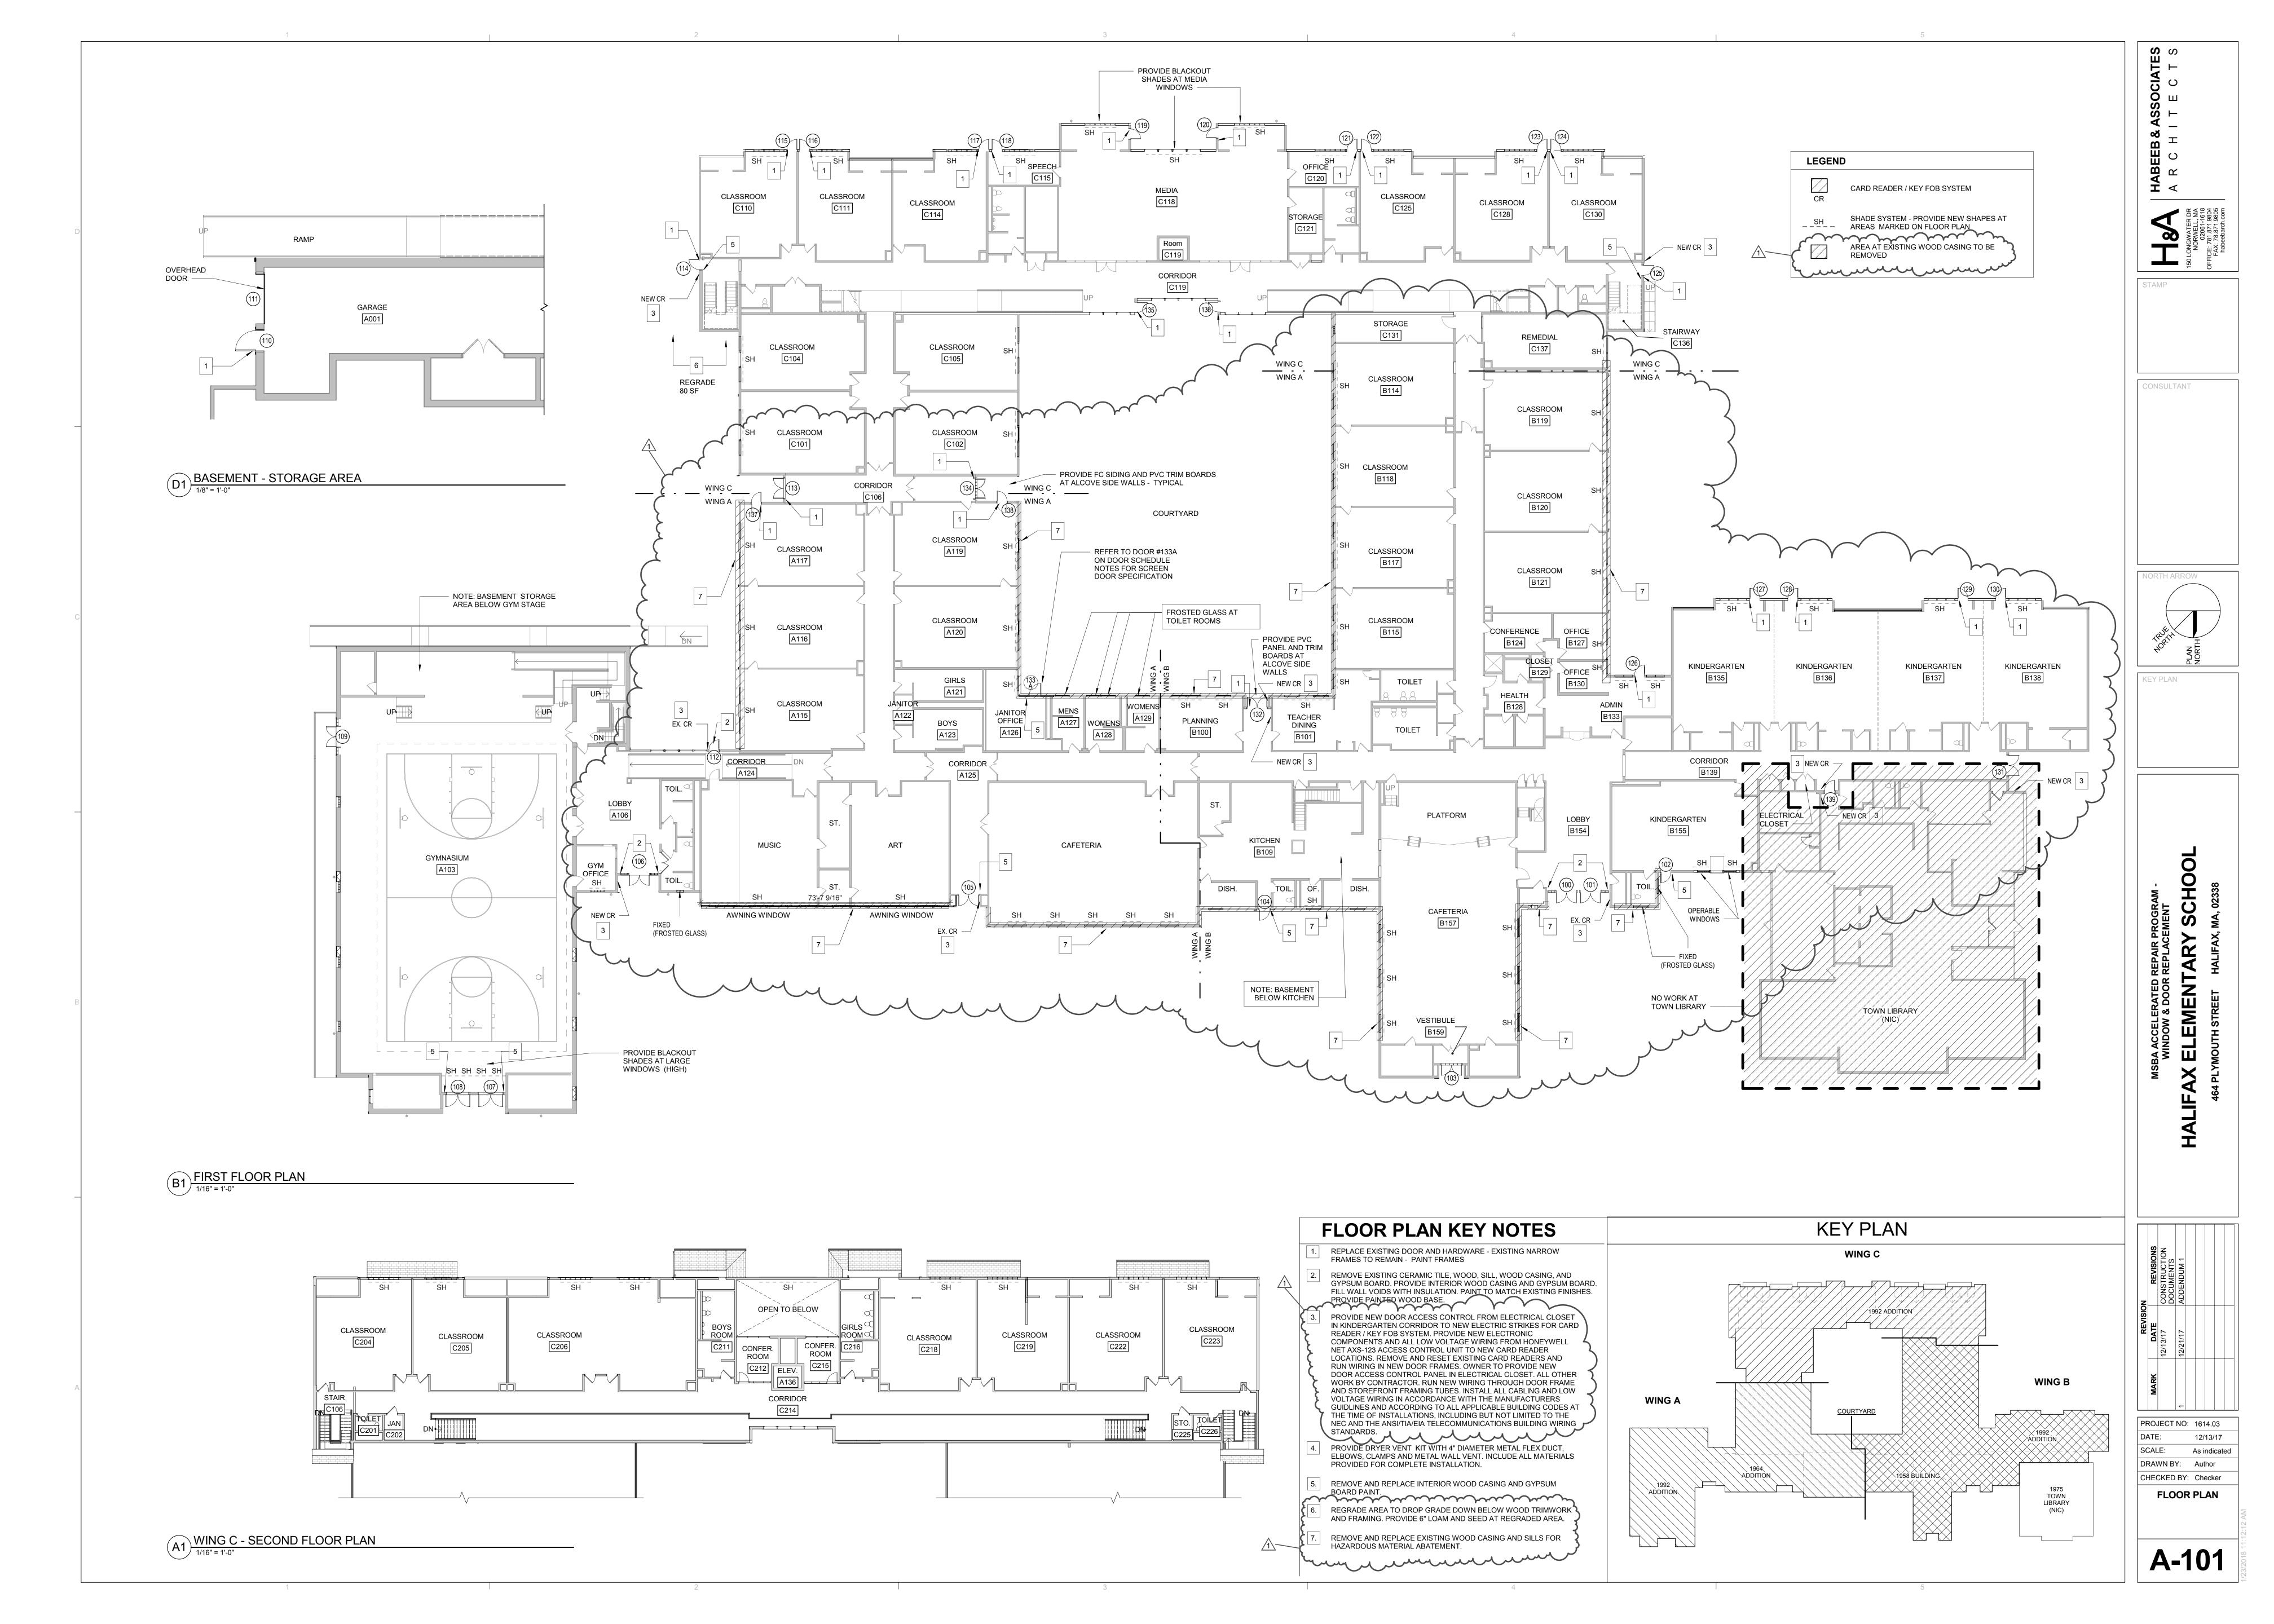


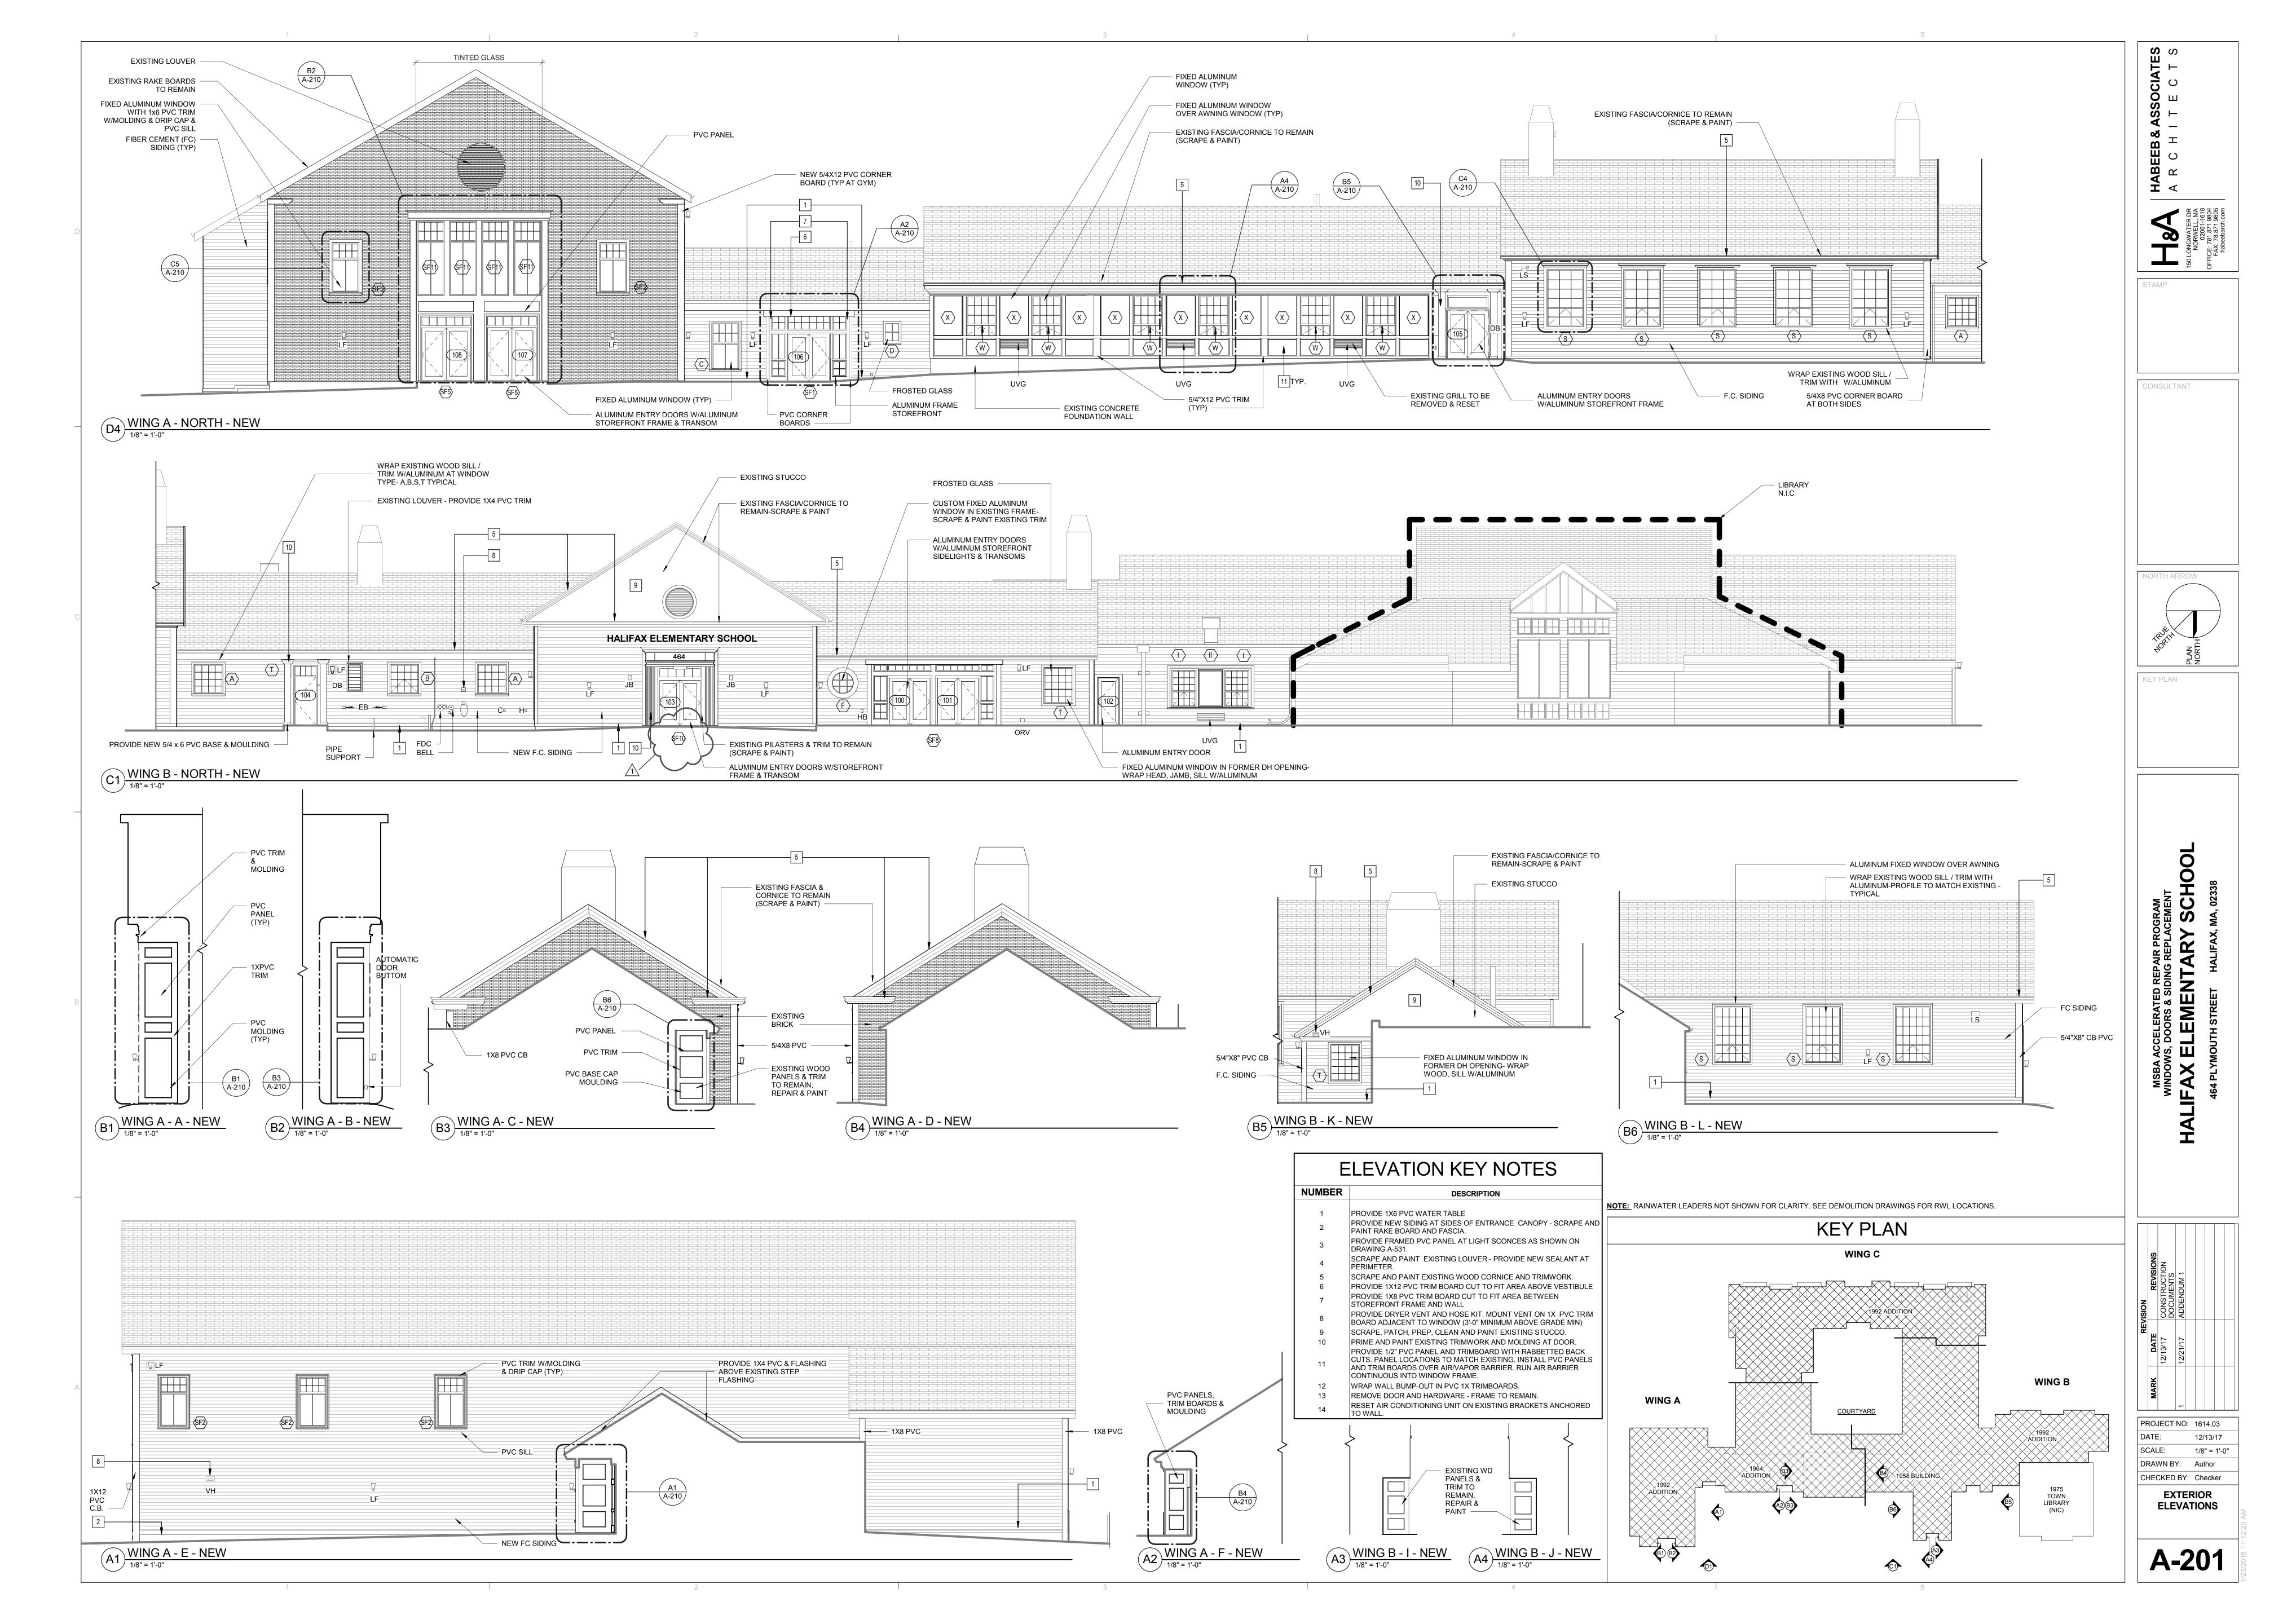


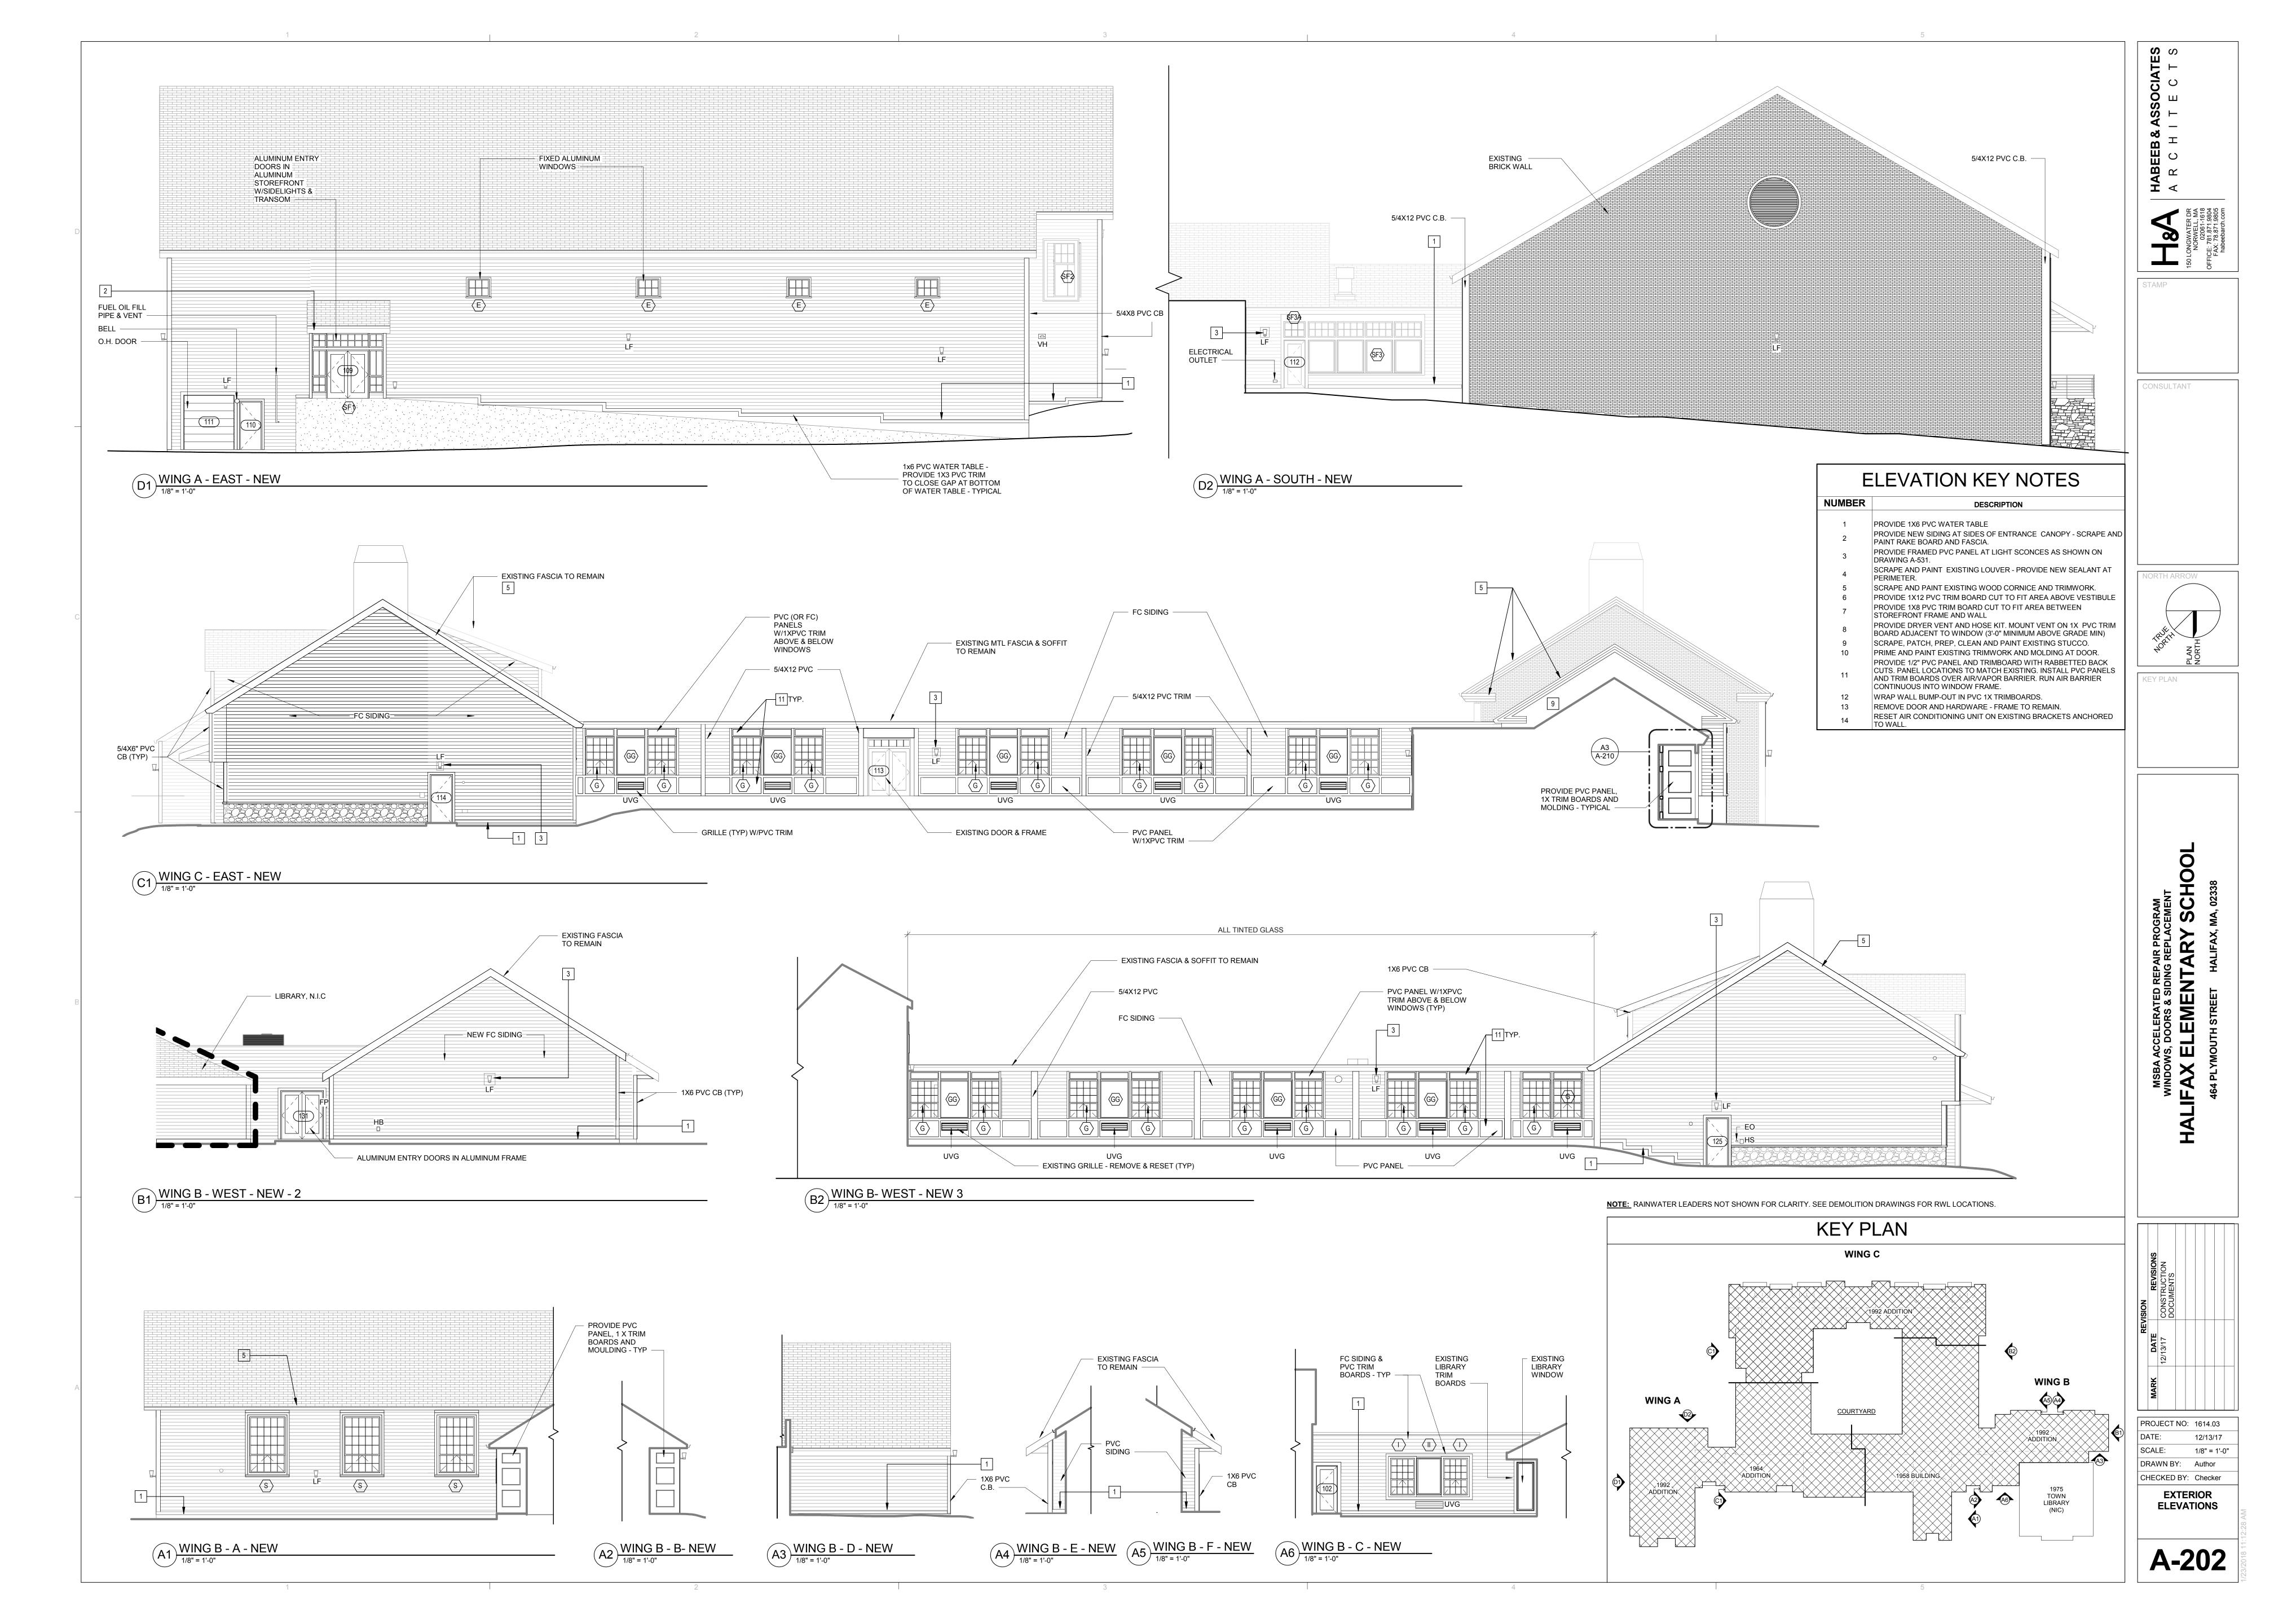


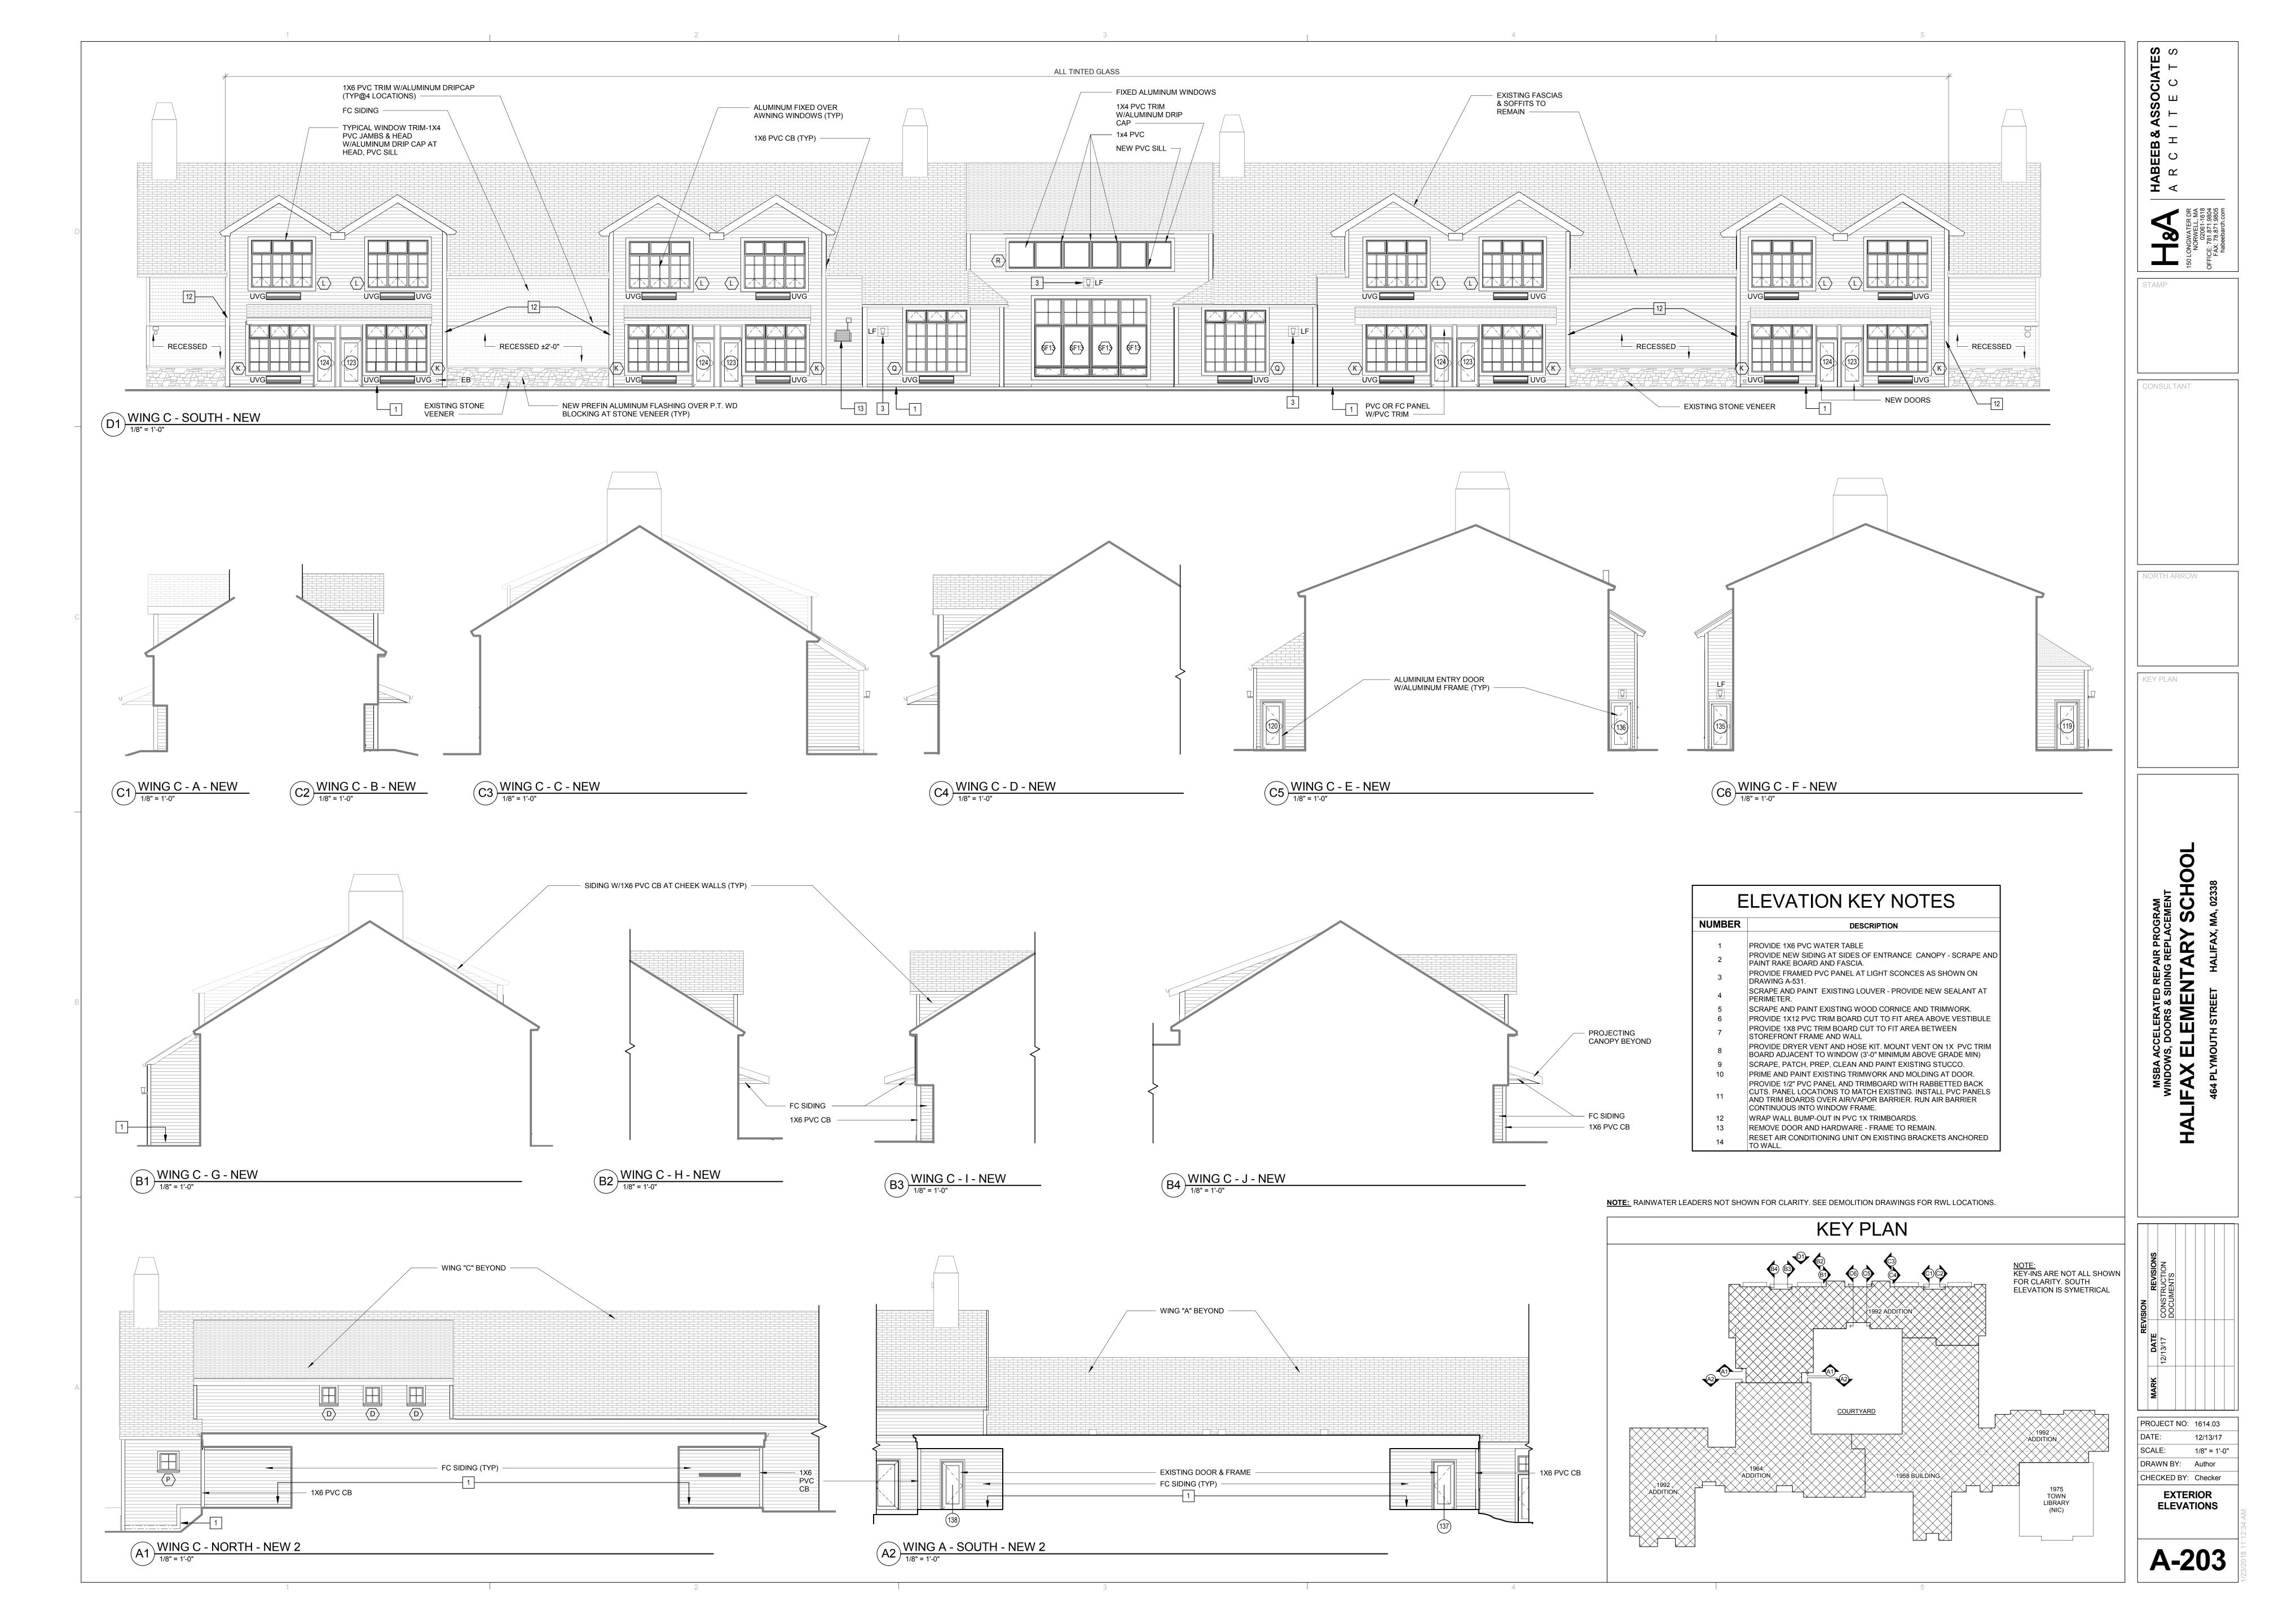

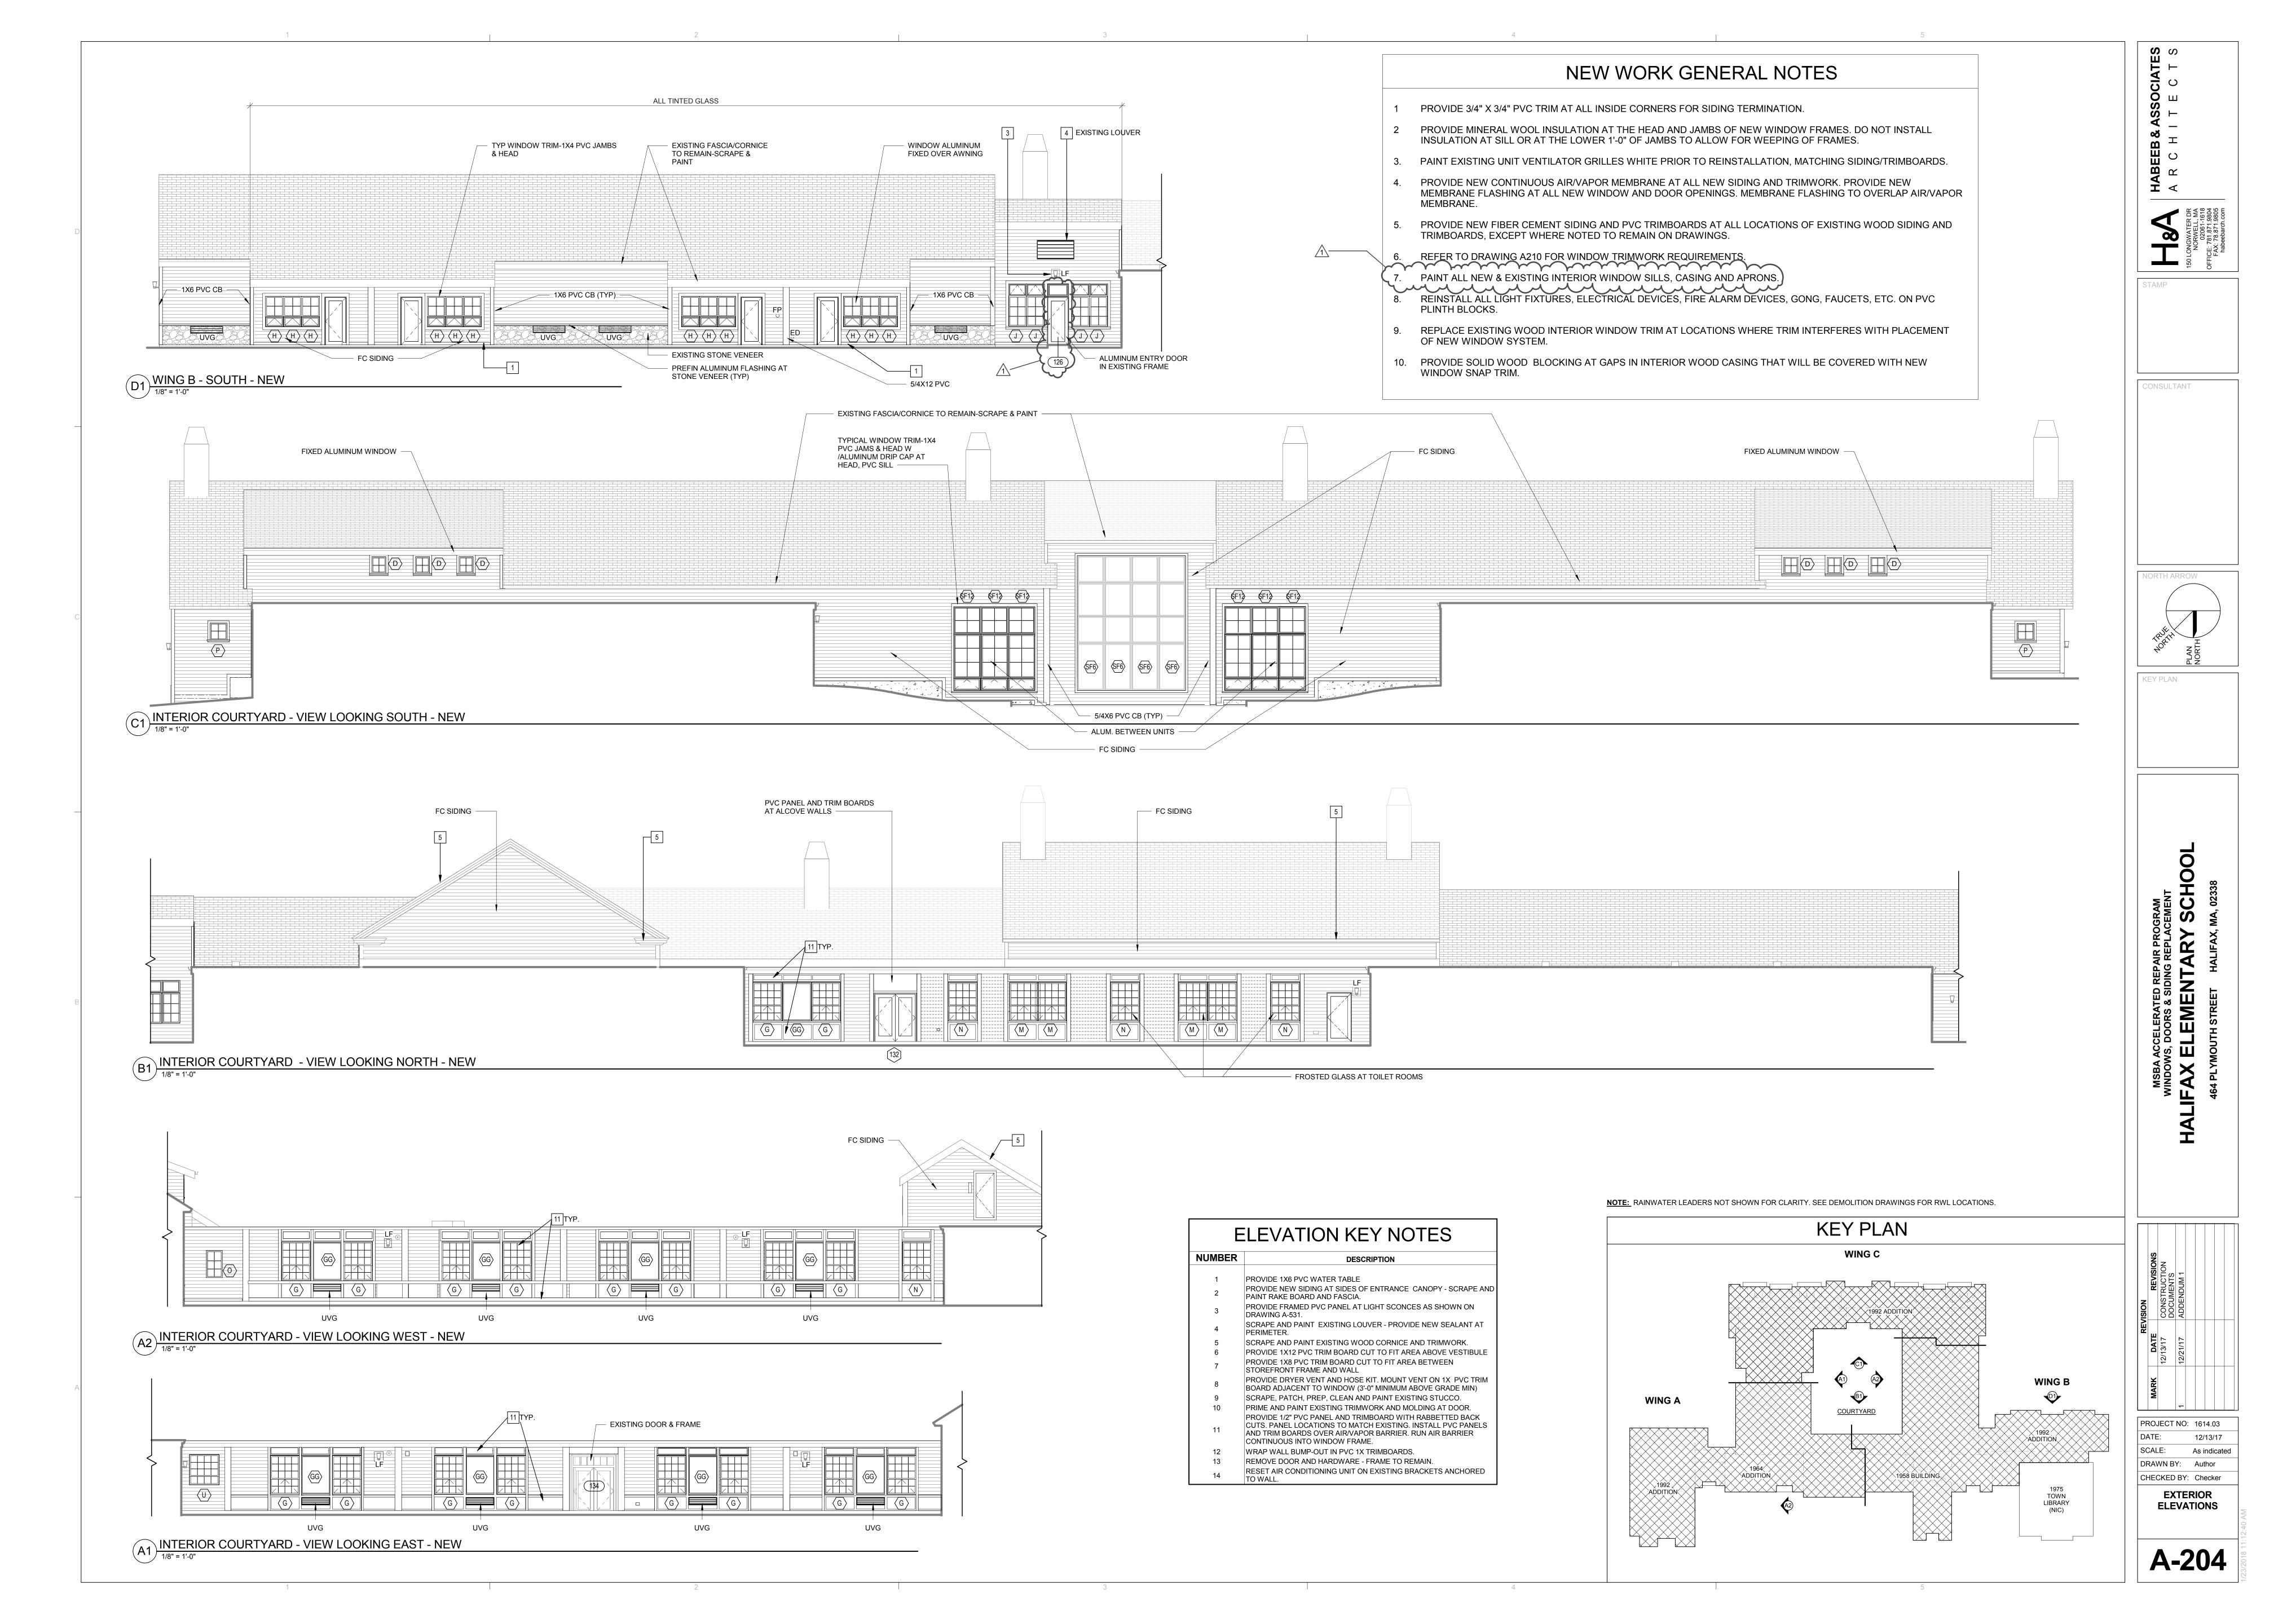

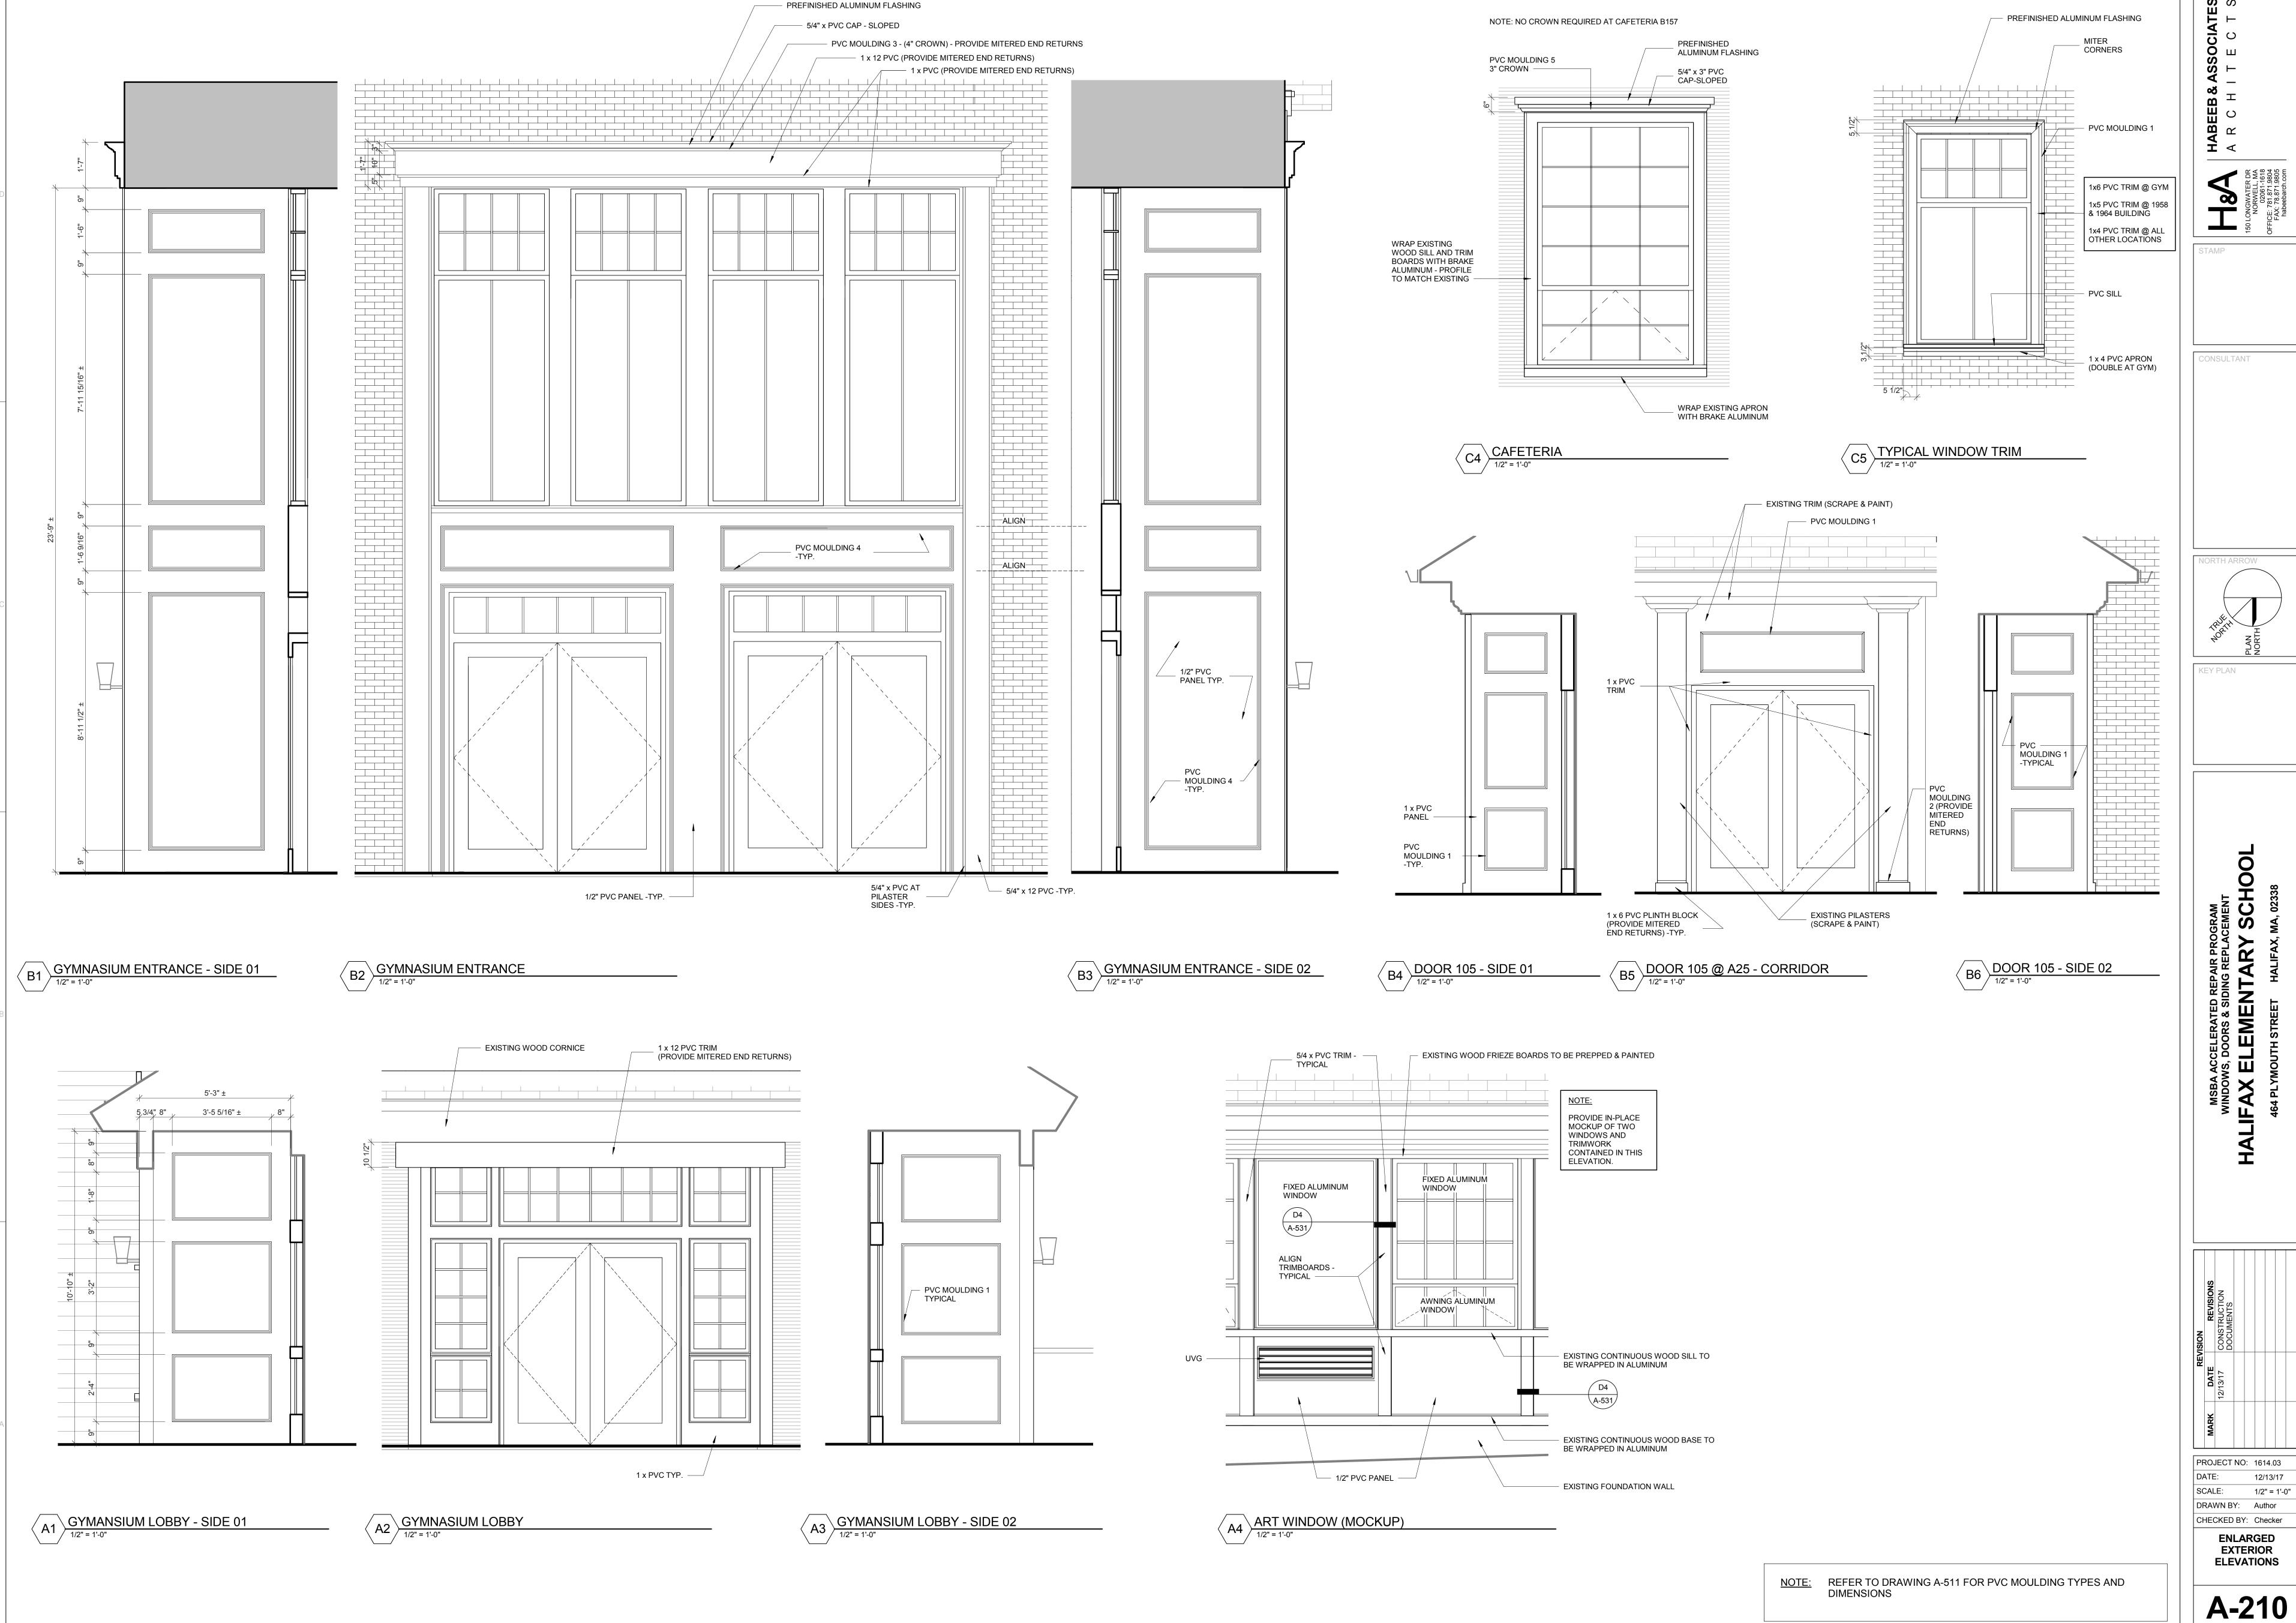

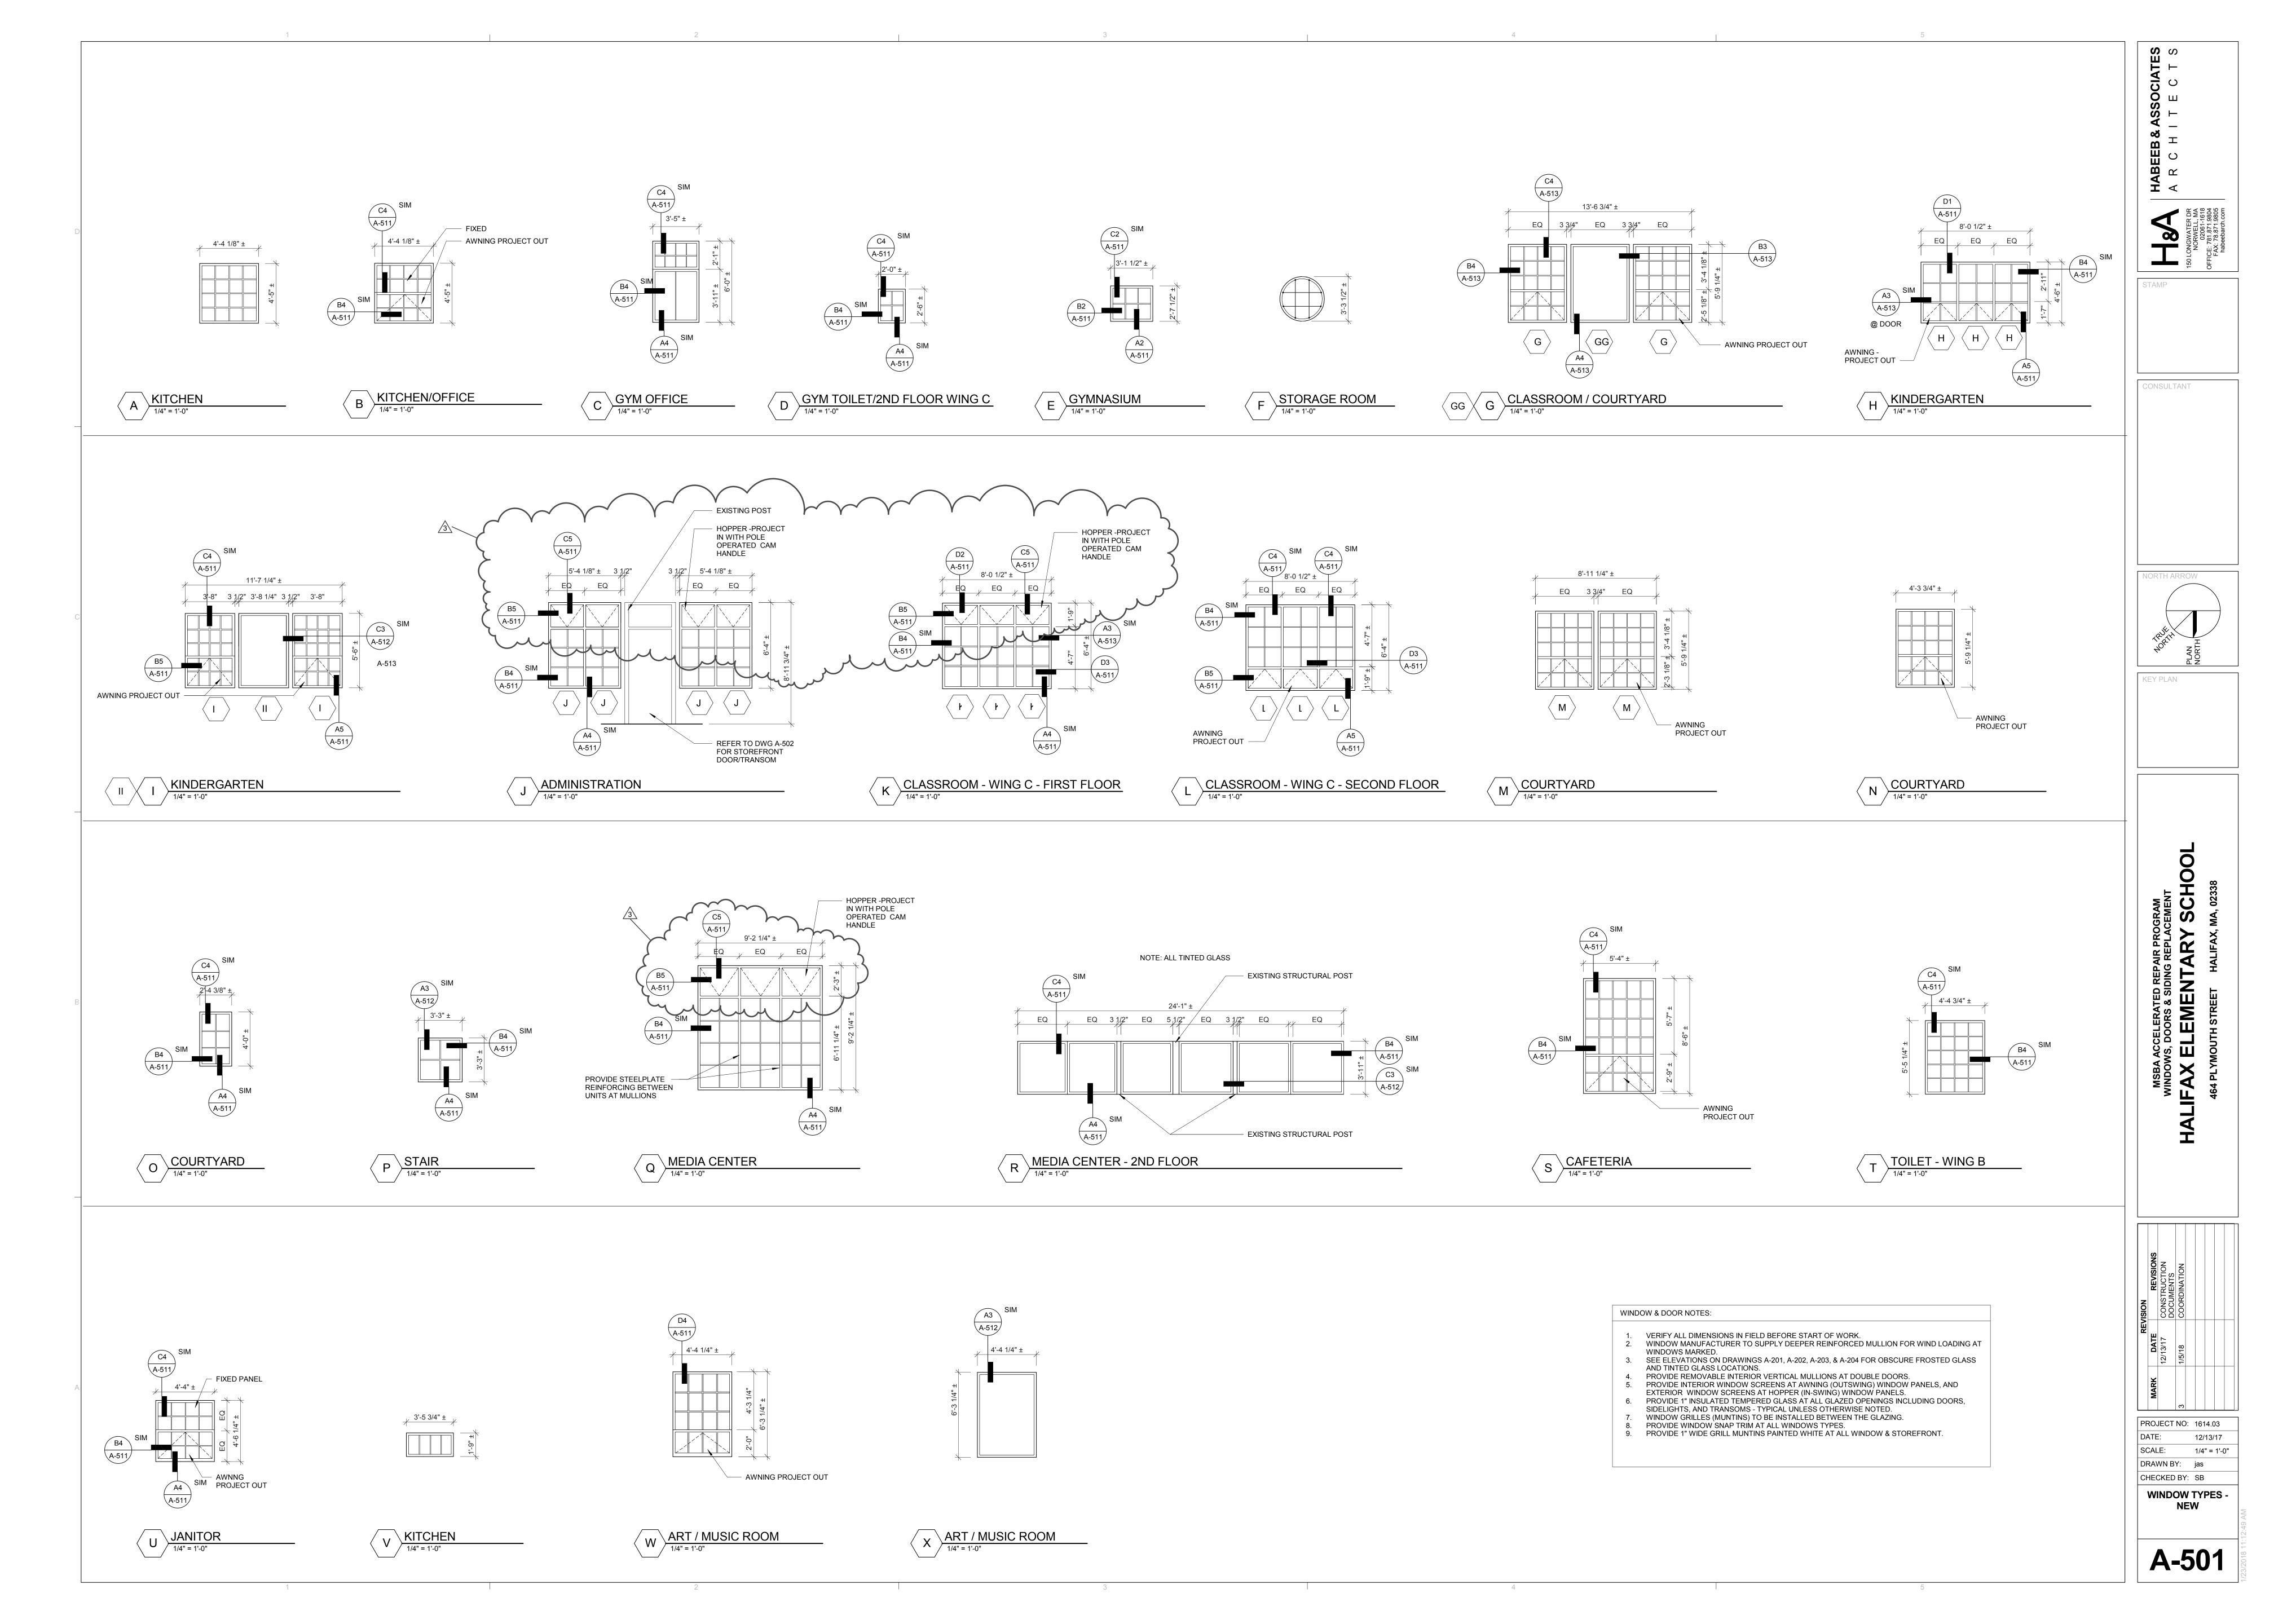

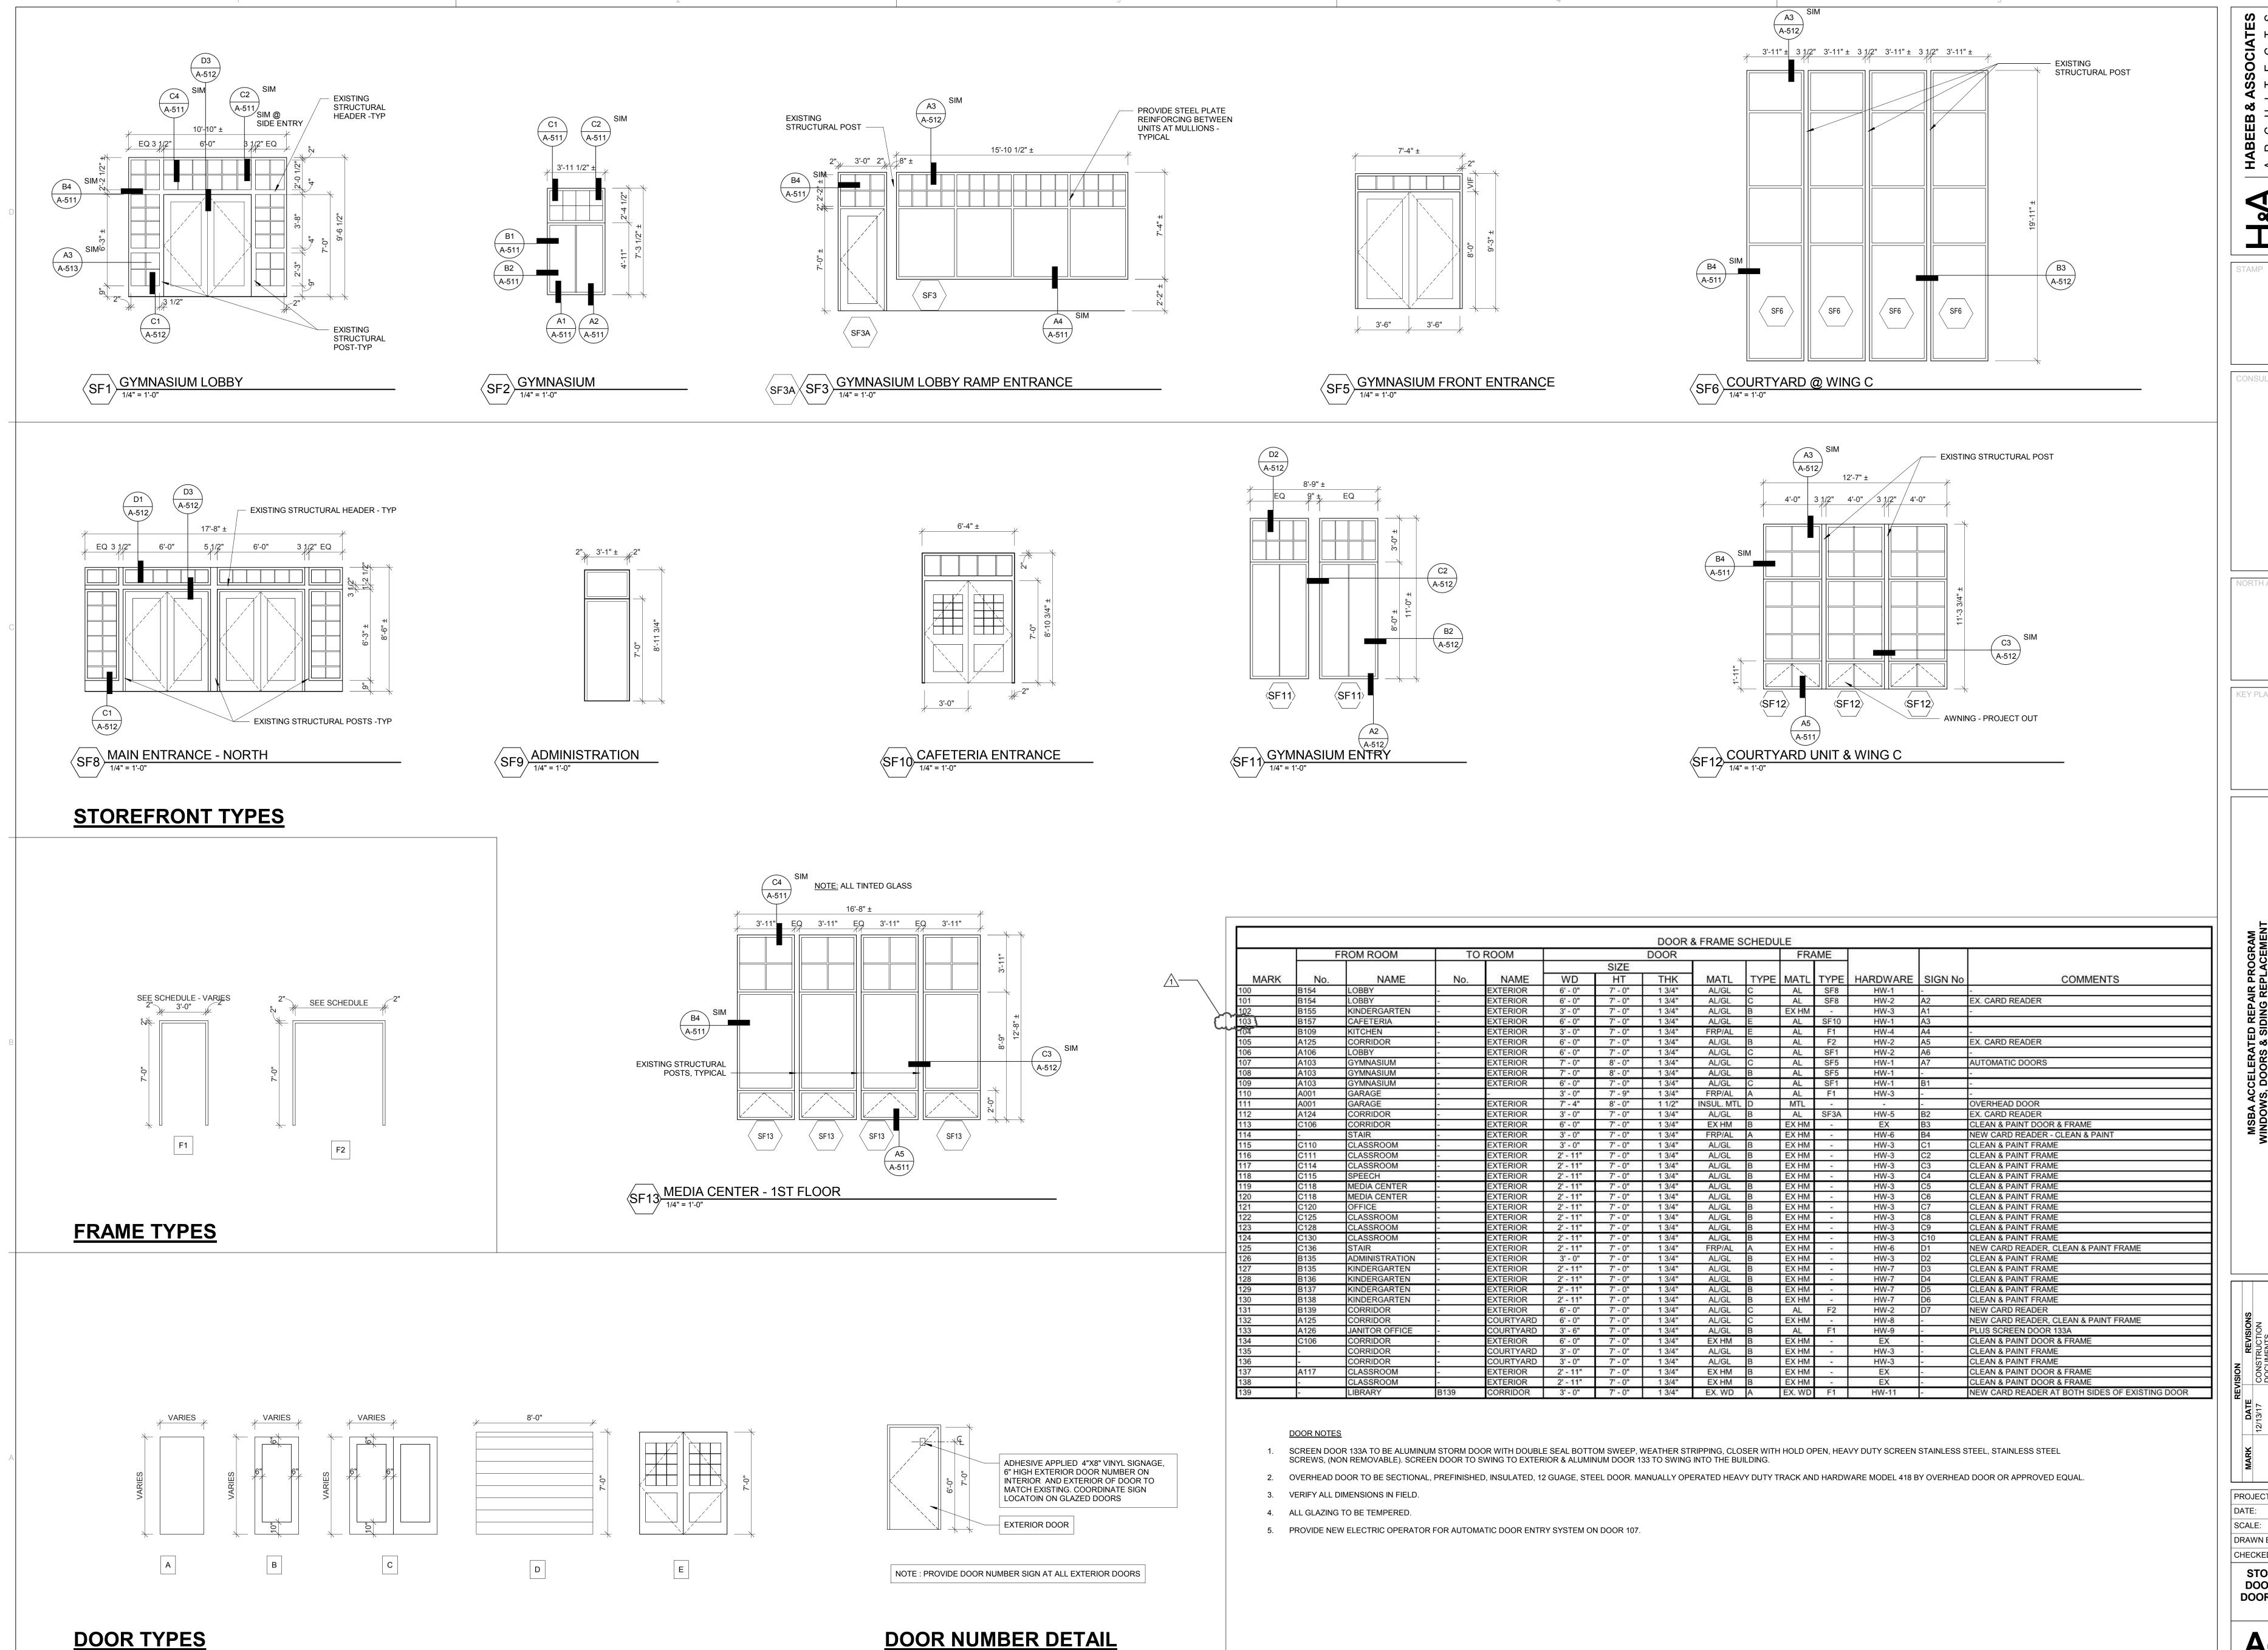


CONSULTANT


MSBA ACCELERATED REPAIR PROGRAM
WINDOWS, DOORS & SIDING REPLACEMENT
HALIFAX ELEMENTARY SCHOOI
464 PLYMOUTH STREET HALIFAX, MA, 02338


PROJECT NO: 1614.03 12/13/17 1/4" = 1'-0"


DRAWN BY: jas CHECKED BY: SB STOREFRONT -DOOR TYPES & DOOR SCHEDULE

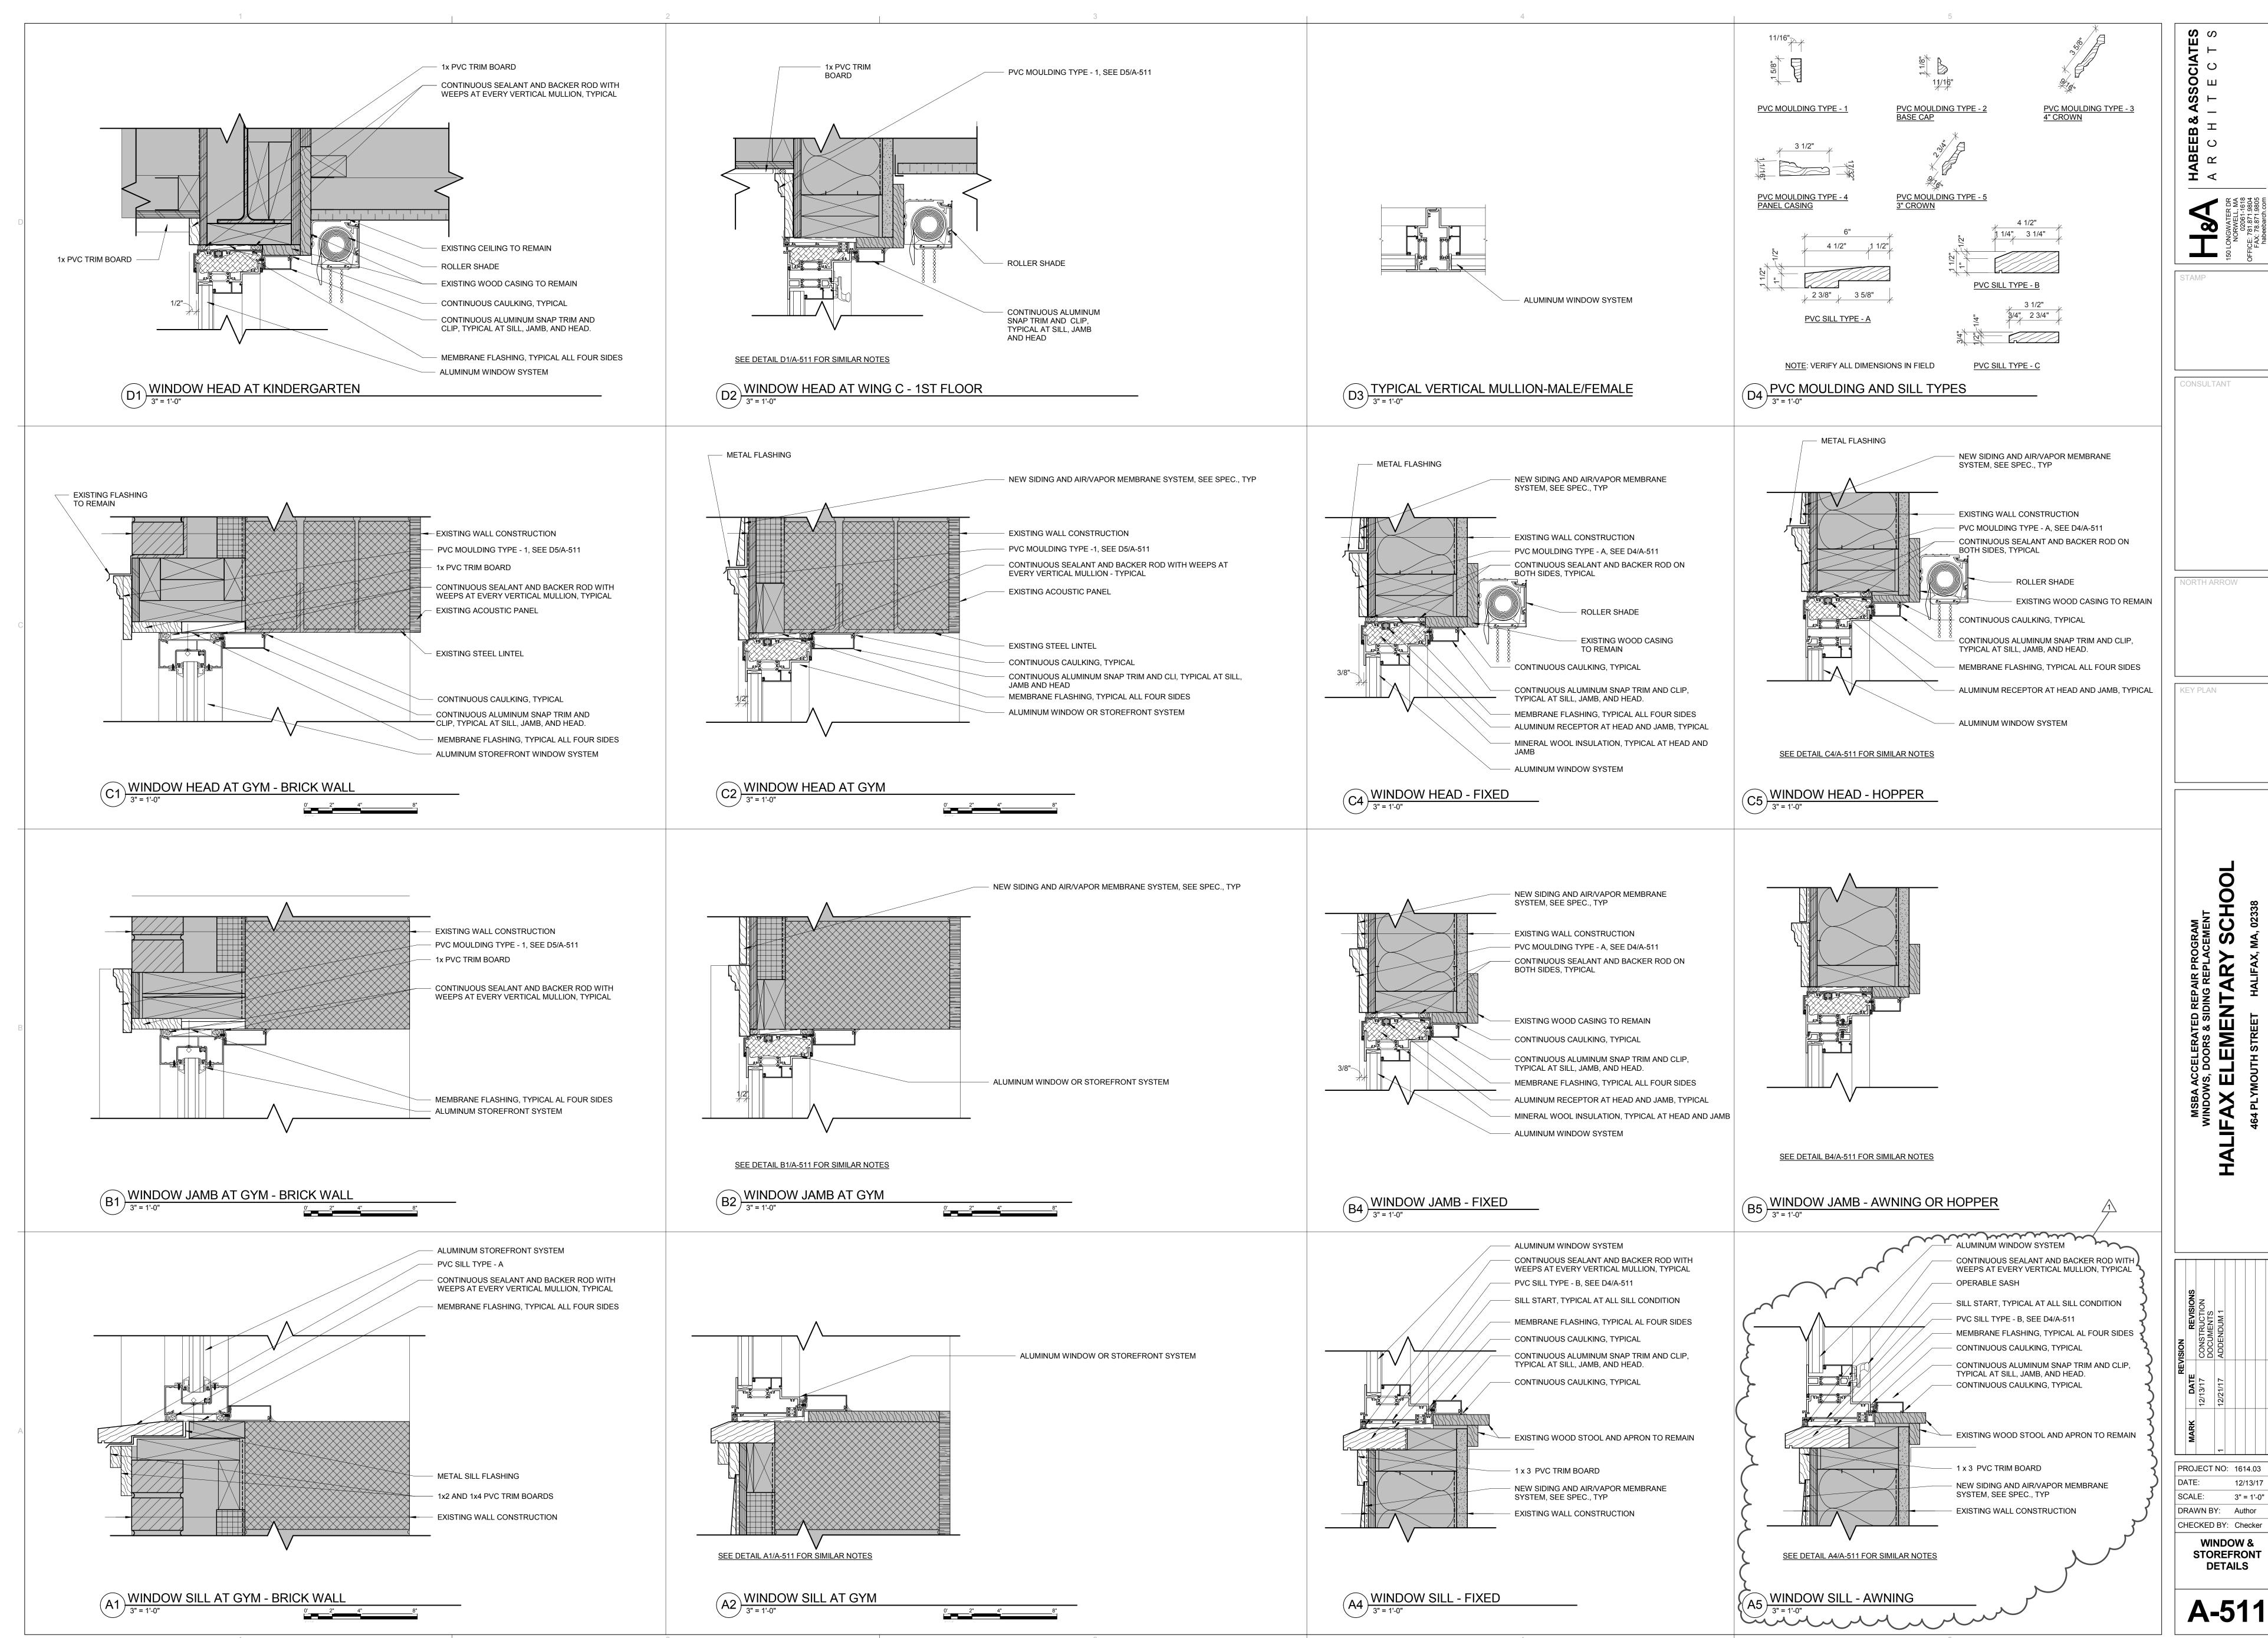


WINDOW & STOREFRONT **DETAILS**

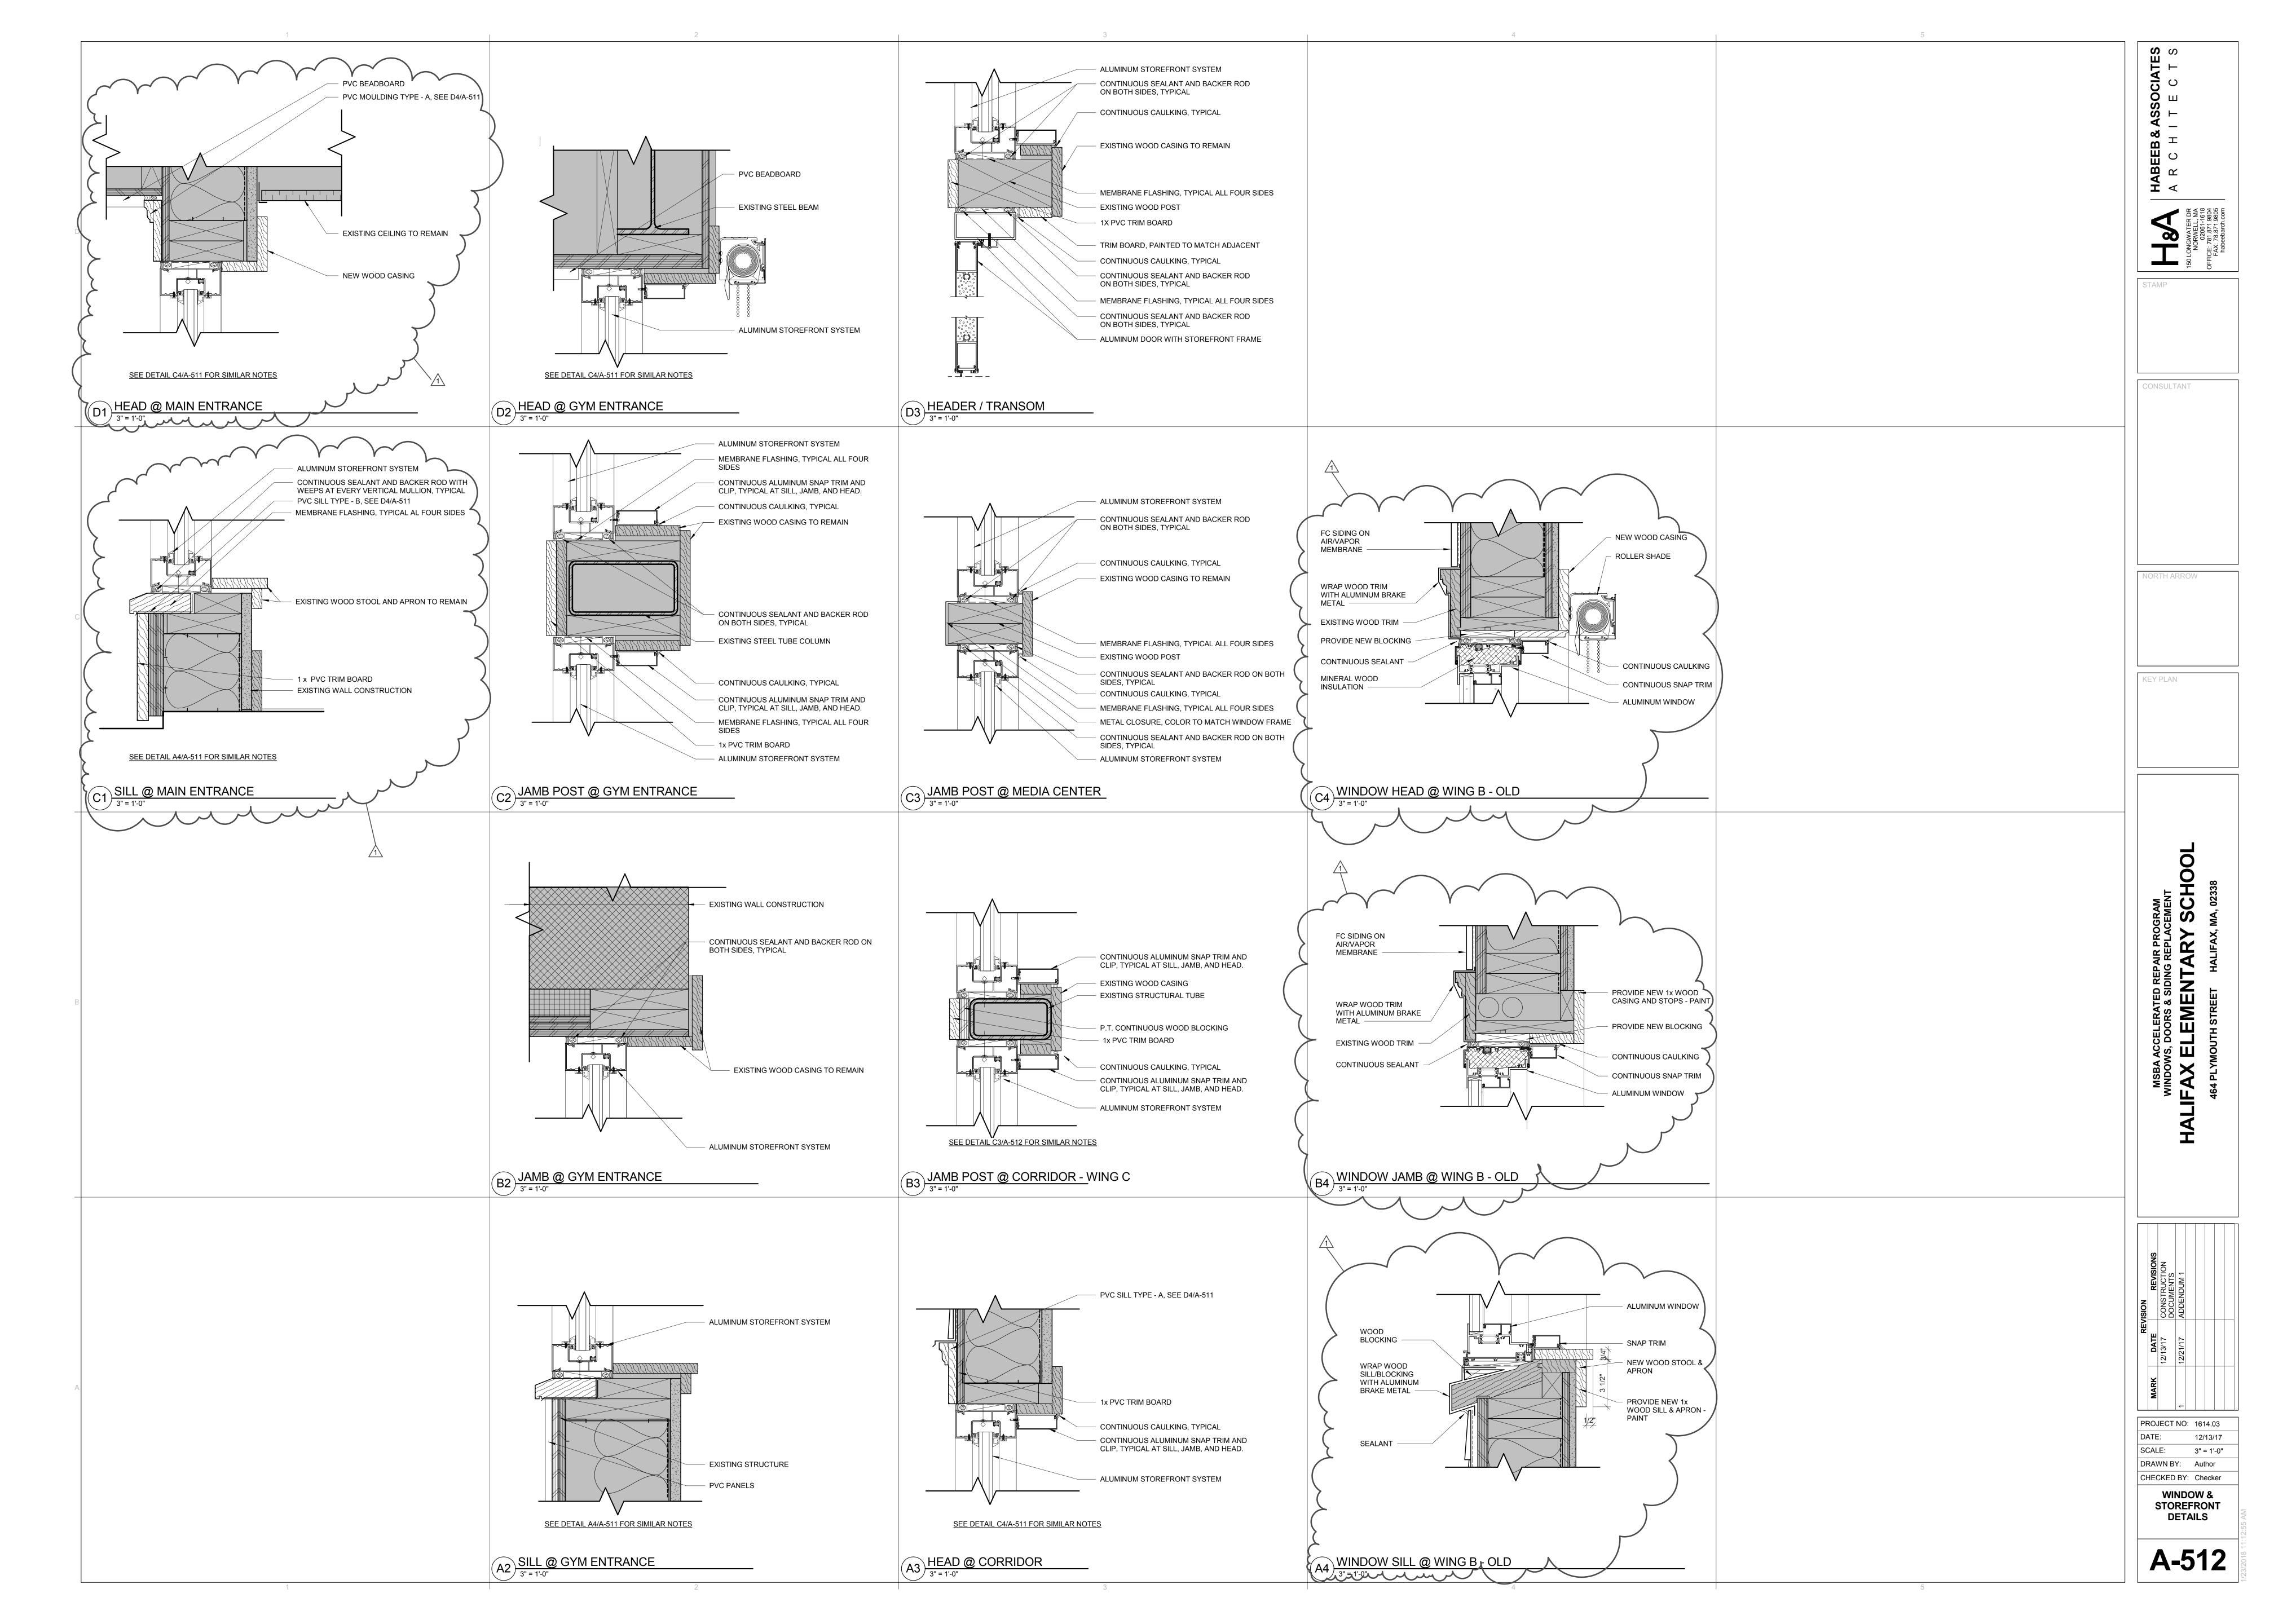

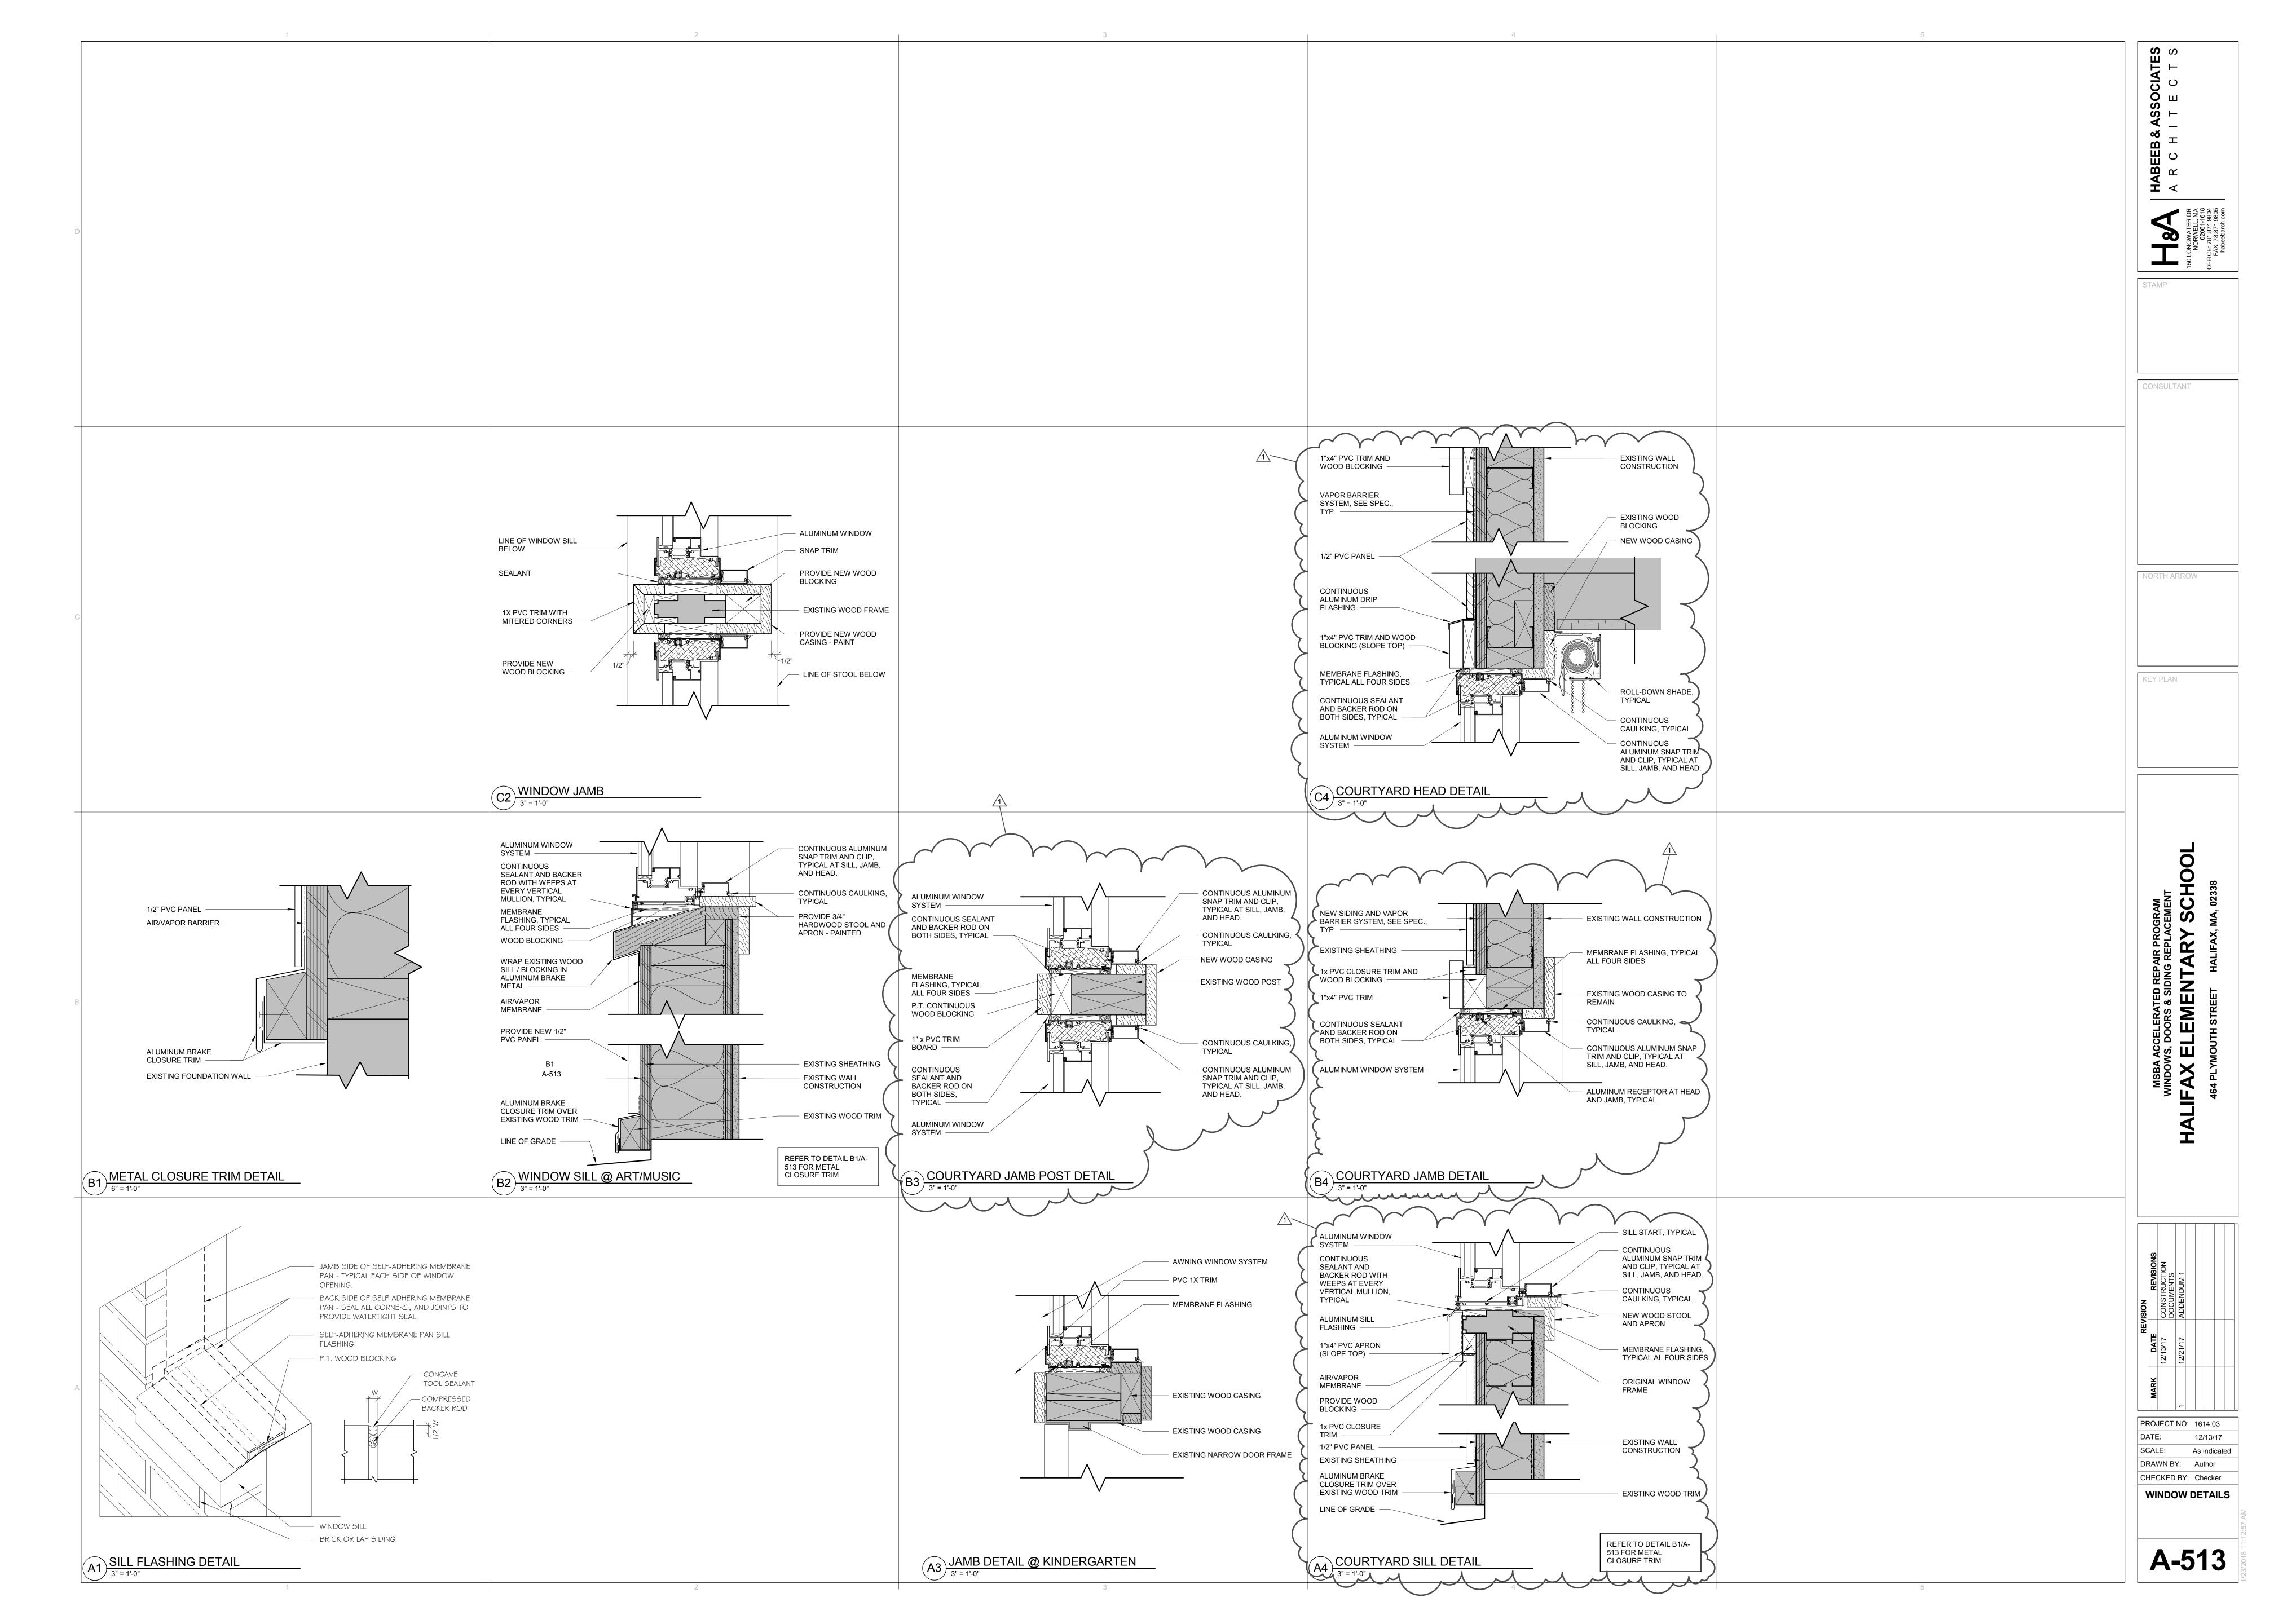

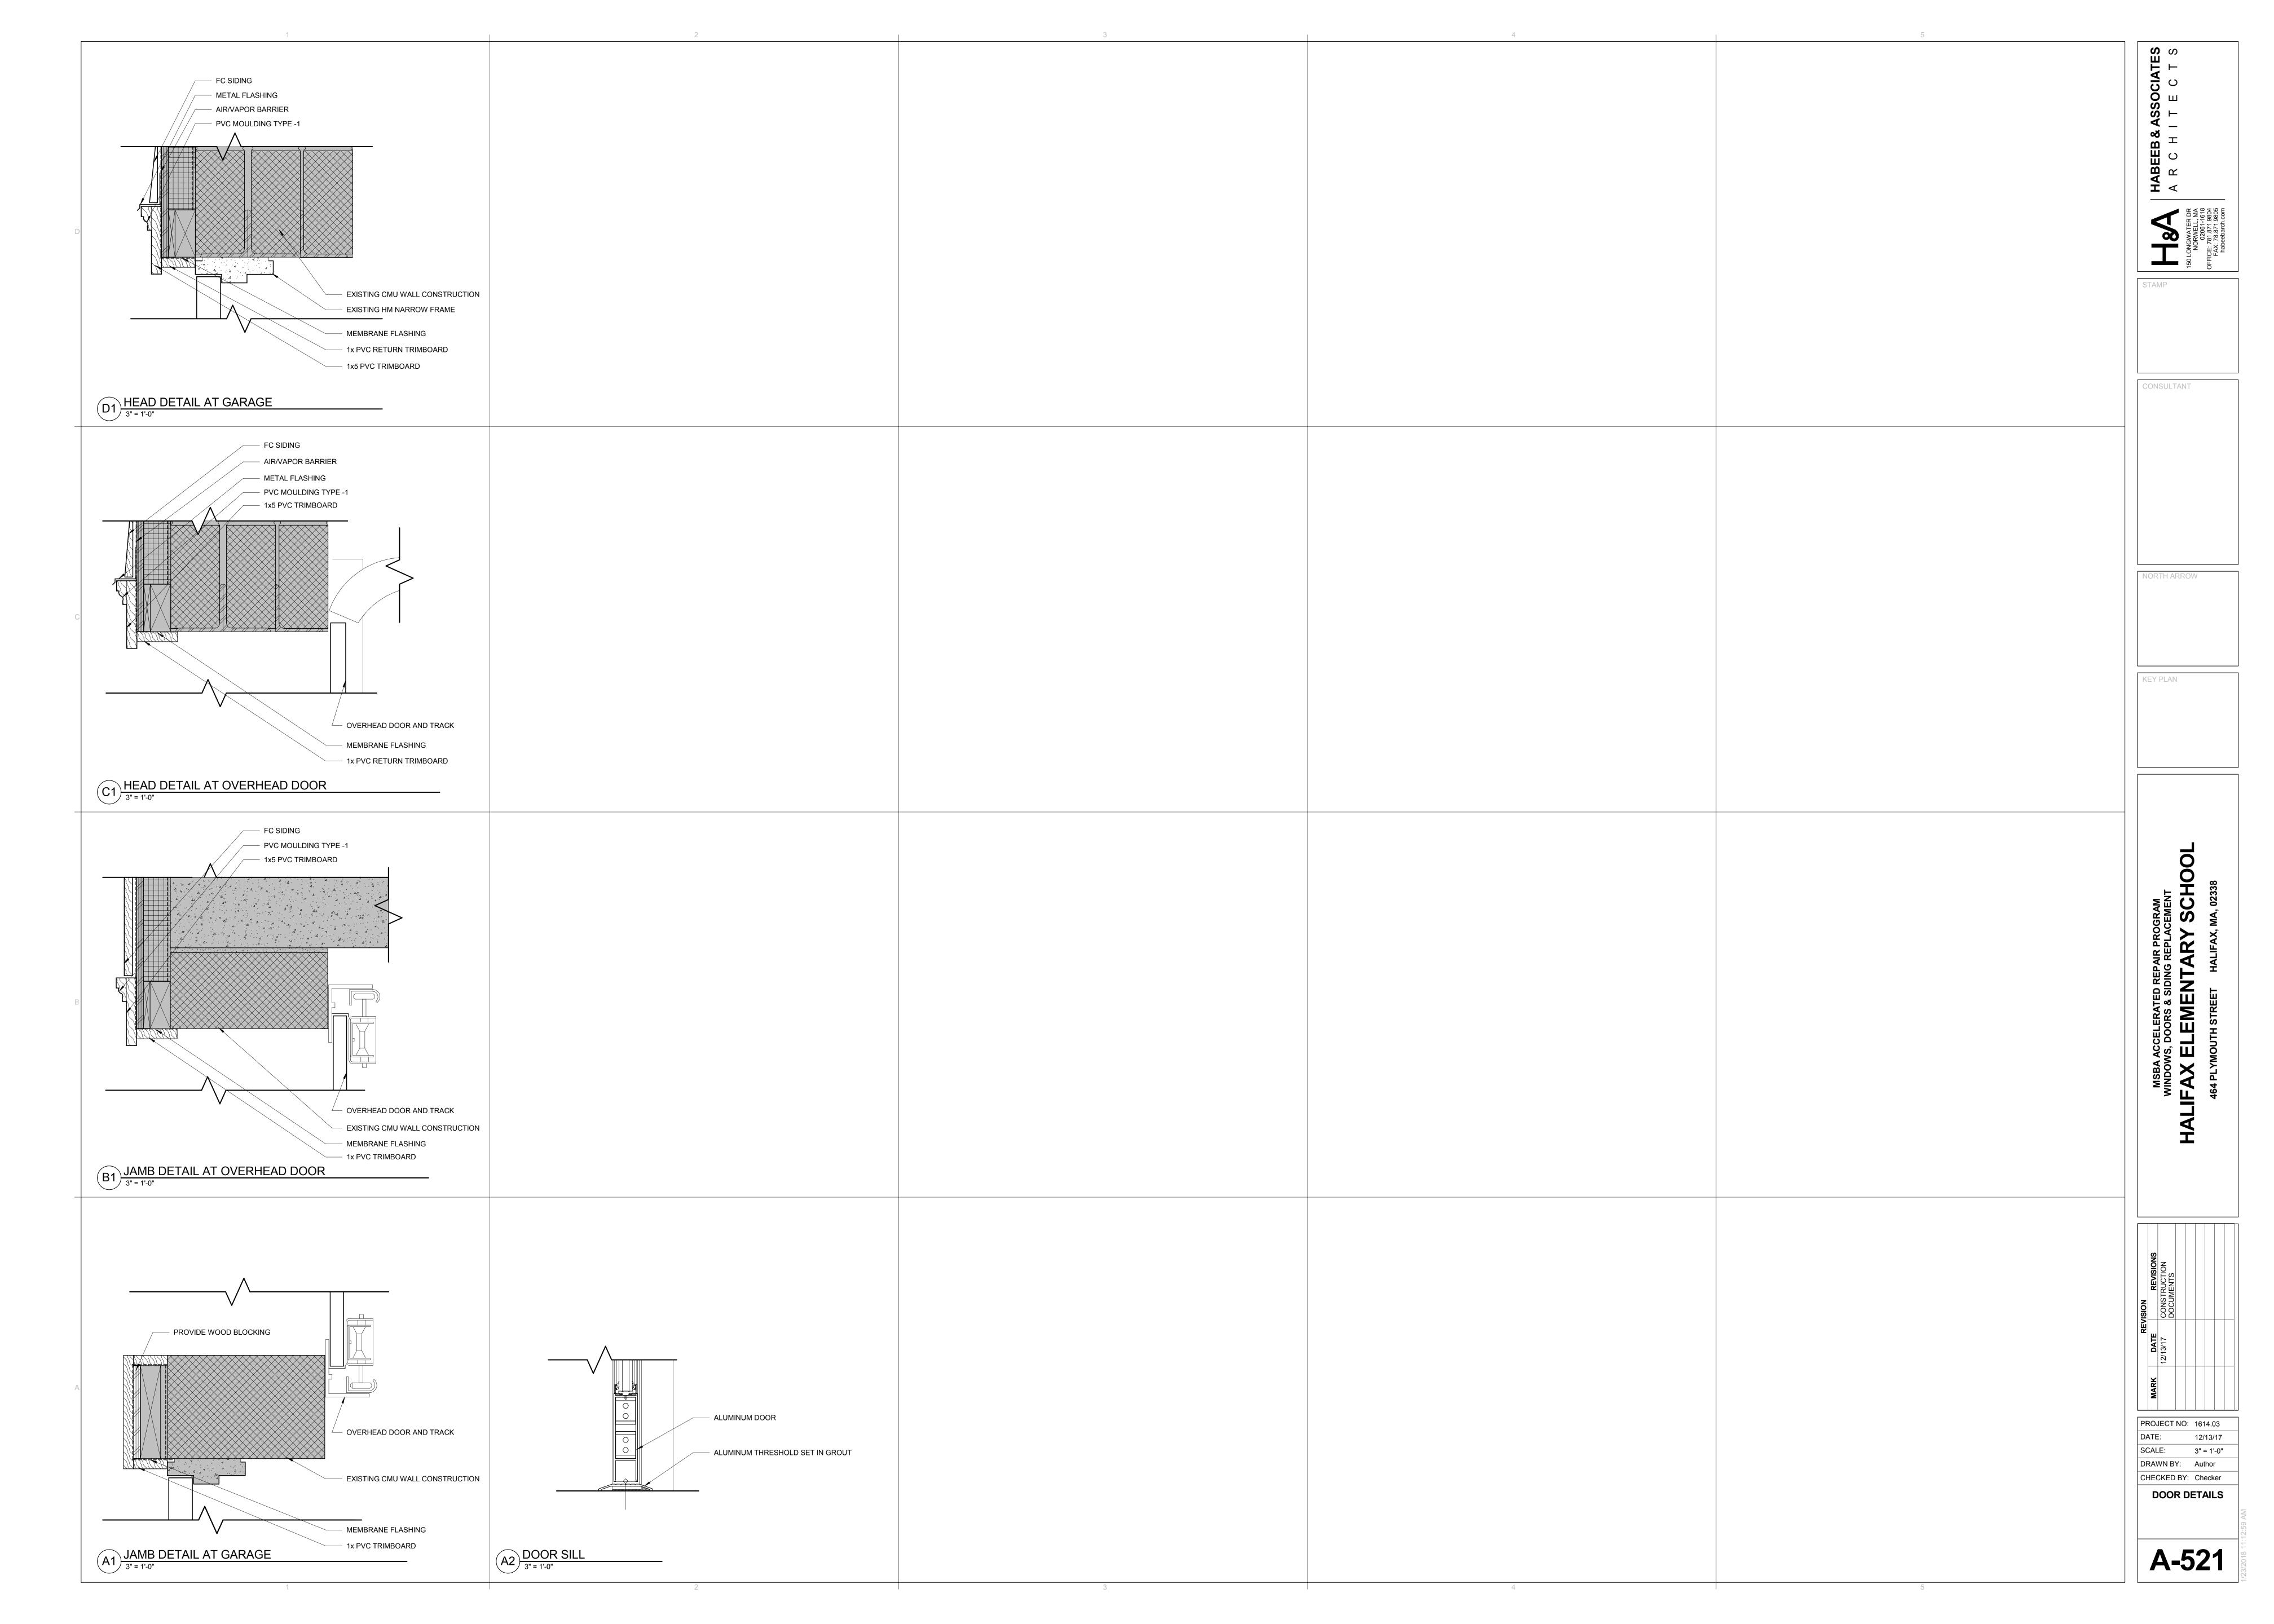

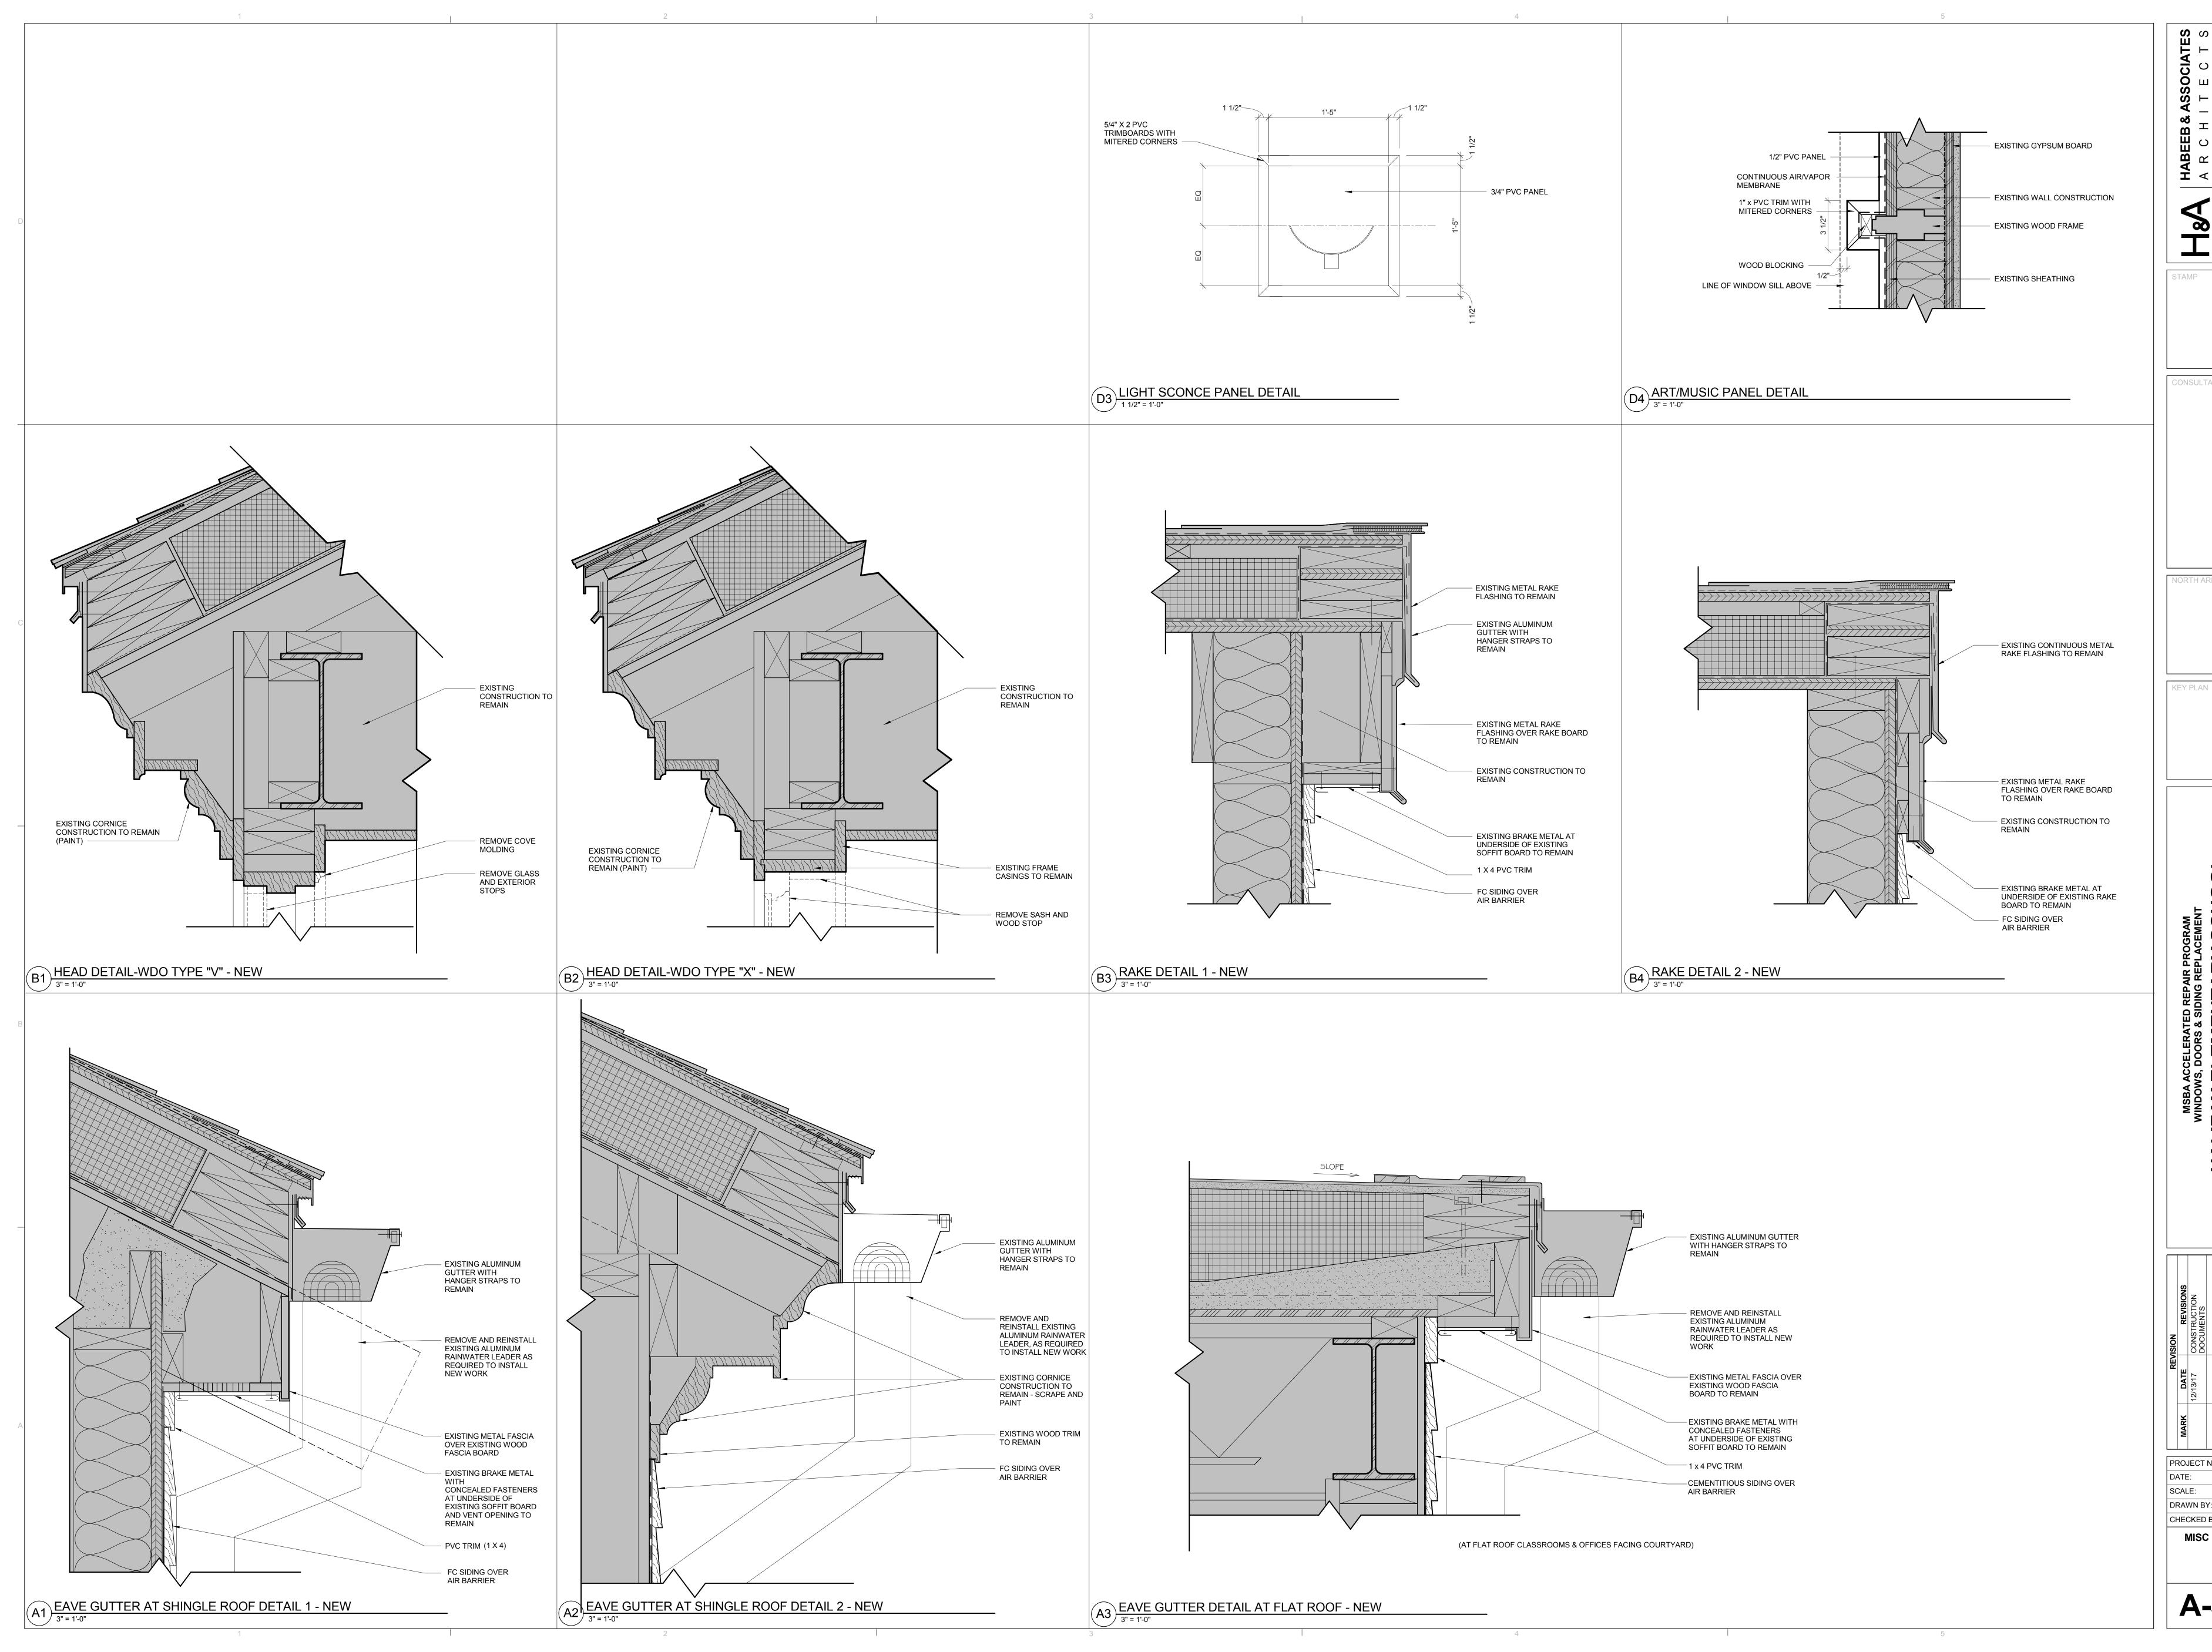

CONSULTANT

PROJECT NO: 1614.03 12/13/17 As indicated DRAWN BY: Author CHECKED BY: Checker

MISC DETAILS

